RIVER POINTE

105 AND 107 COLCHESTER DRIVE KNIGHTDALE, NC 27545

MASTER PLAN

PROJECT NUMBER: CDV21001
DATE: AUGUST 22, 2022
CASE #: 733581
ZMA-7-22

ZONING CONDITIONS:

1. TO PERMIT A DENSITY NECESSARY TO SUPPORT THE SITE'S REQUIRED INFRASTRUCTURE AND RECREATIONAL IMPROVEMENTS, RIVER POINTE WILL INCLUDE UP TO 28 SINGLE-FAMILY UNITS AS FRONT-LOADED LOTS WITH A MINIMUM 70' WIDTH (INSTEAD OF 80')

2. FRONT-LOADED SFD DIMENSIONAL MODIFICATIONS: TO CREATE AN INTERESTING STREETSCAPE AND ENCOURAGE INTERACTION BETWEEN THE PUBLIC AND PRIVATE REALM, FRONT-LOADED SINGLE-FAMILY DWELLINGS IN RIVER POINTE WILL BE SERVED BY DRIVEWAYS THAT ARE A MINIMUM LENGTH OF 25' RATHER THAN THE UDO REQUIREMENT OF 35'. FURTHERMORE, REAR SETBACKS OF 15' SHALL BE APPLIED RATHER THAN 25'. THE MINIMUM SIDE SETBACKS SHALL BE A STANDARD 5 FT.

3. REAR-LOADED SFD DIMENSIONAL MODIFICATIONS: REAR-LOADED SINGLE-FAMILY DWELLINGS IN PROJECT HOPE WILL BE SERVED BY DRIVEWAYS THAT ARE A MINIMUM LENGTH OF 20' RATHER THAN THE UDO REQUIREMENT OF 35'.

FURTHERMORE, REAR SETBACKS OF 15' SHALL BE APPLIED RATHER THAN 25'. MINIMUM SIDE SETBACKS SHALL BE 4 FT.


4. DUE TO THIS SITE BEING A RELATIVELY SMALL INFILL PROJECT SURROUNDED BY EXISTING DETACHED SINGLE-FAMILY SUBDIVISIONS, RIVER POINTE SHALL BE PERMITTED TO HAVE 100% SINGLE FAMILY DWELLINGS (RATHER THAN A MIX OF

5. SECTION 11.3E7 OF THE KNIGHTDALE UDO WOULD REQUIRE A MINIMUM CONNECTIVITY INDEX OF 1.4 FOR A GR3-PUD. DUE TO ENVIRONMENTAL FEATURES TO THE WEST AND HOA OWNED AND PRESERVED OPEN SPACE TO THE NORTH, RIVER POINTE SHALL BE PERMITTED A MINIMUM CONNECTIVITY INDEX OF 1.3. ADDITIONAL CONNECTIONS ARE INFEASIBLE DUE TO ENVIRONMENTAL SITE CONSTRAINTS.

SFD, TOWNHOMES, AND MF PER THE STANDARD DISTRIBUTION OF USE TABLE CONTAINED IN SECTION 11.1B OF THE UDO).

6. MASS GRADING SHALL BE PERMITTED FOR FRONT-LOADED LOTS 60' OR GREATER. ADDITIONAL DETAILS AND JUSTIFICATION IS PROVIDED IN THE PUD DOCUMENT.

7. ALL STRUCTURES SHALL ADHERE TO THE ADDITIONAL ARCHITECTURAL STANDARDS CONTAINED WITHIN THE

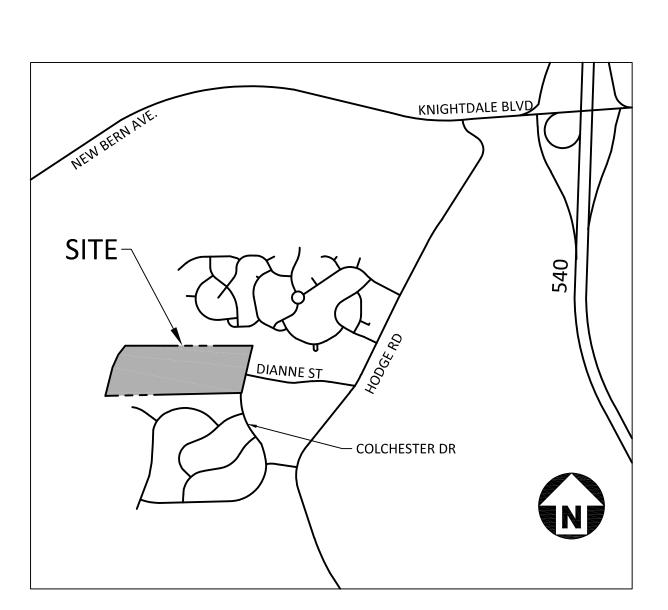

WATER ALLOCATION POINTS - RIVER POINTE

PROPOSED POINTS	50 POINTS (15 BASE POINTS + 35 BONUS POINTS)
ARCHITECTURAL DESIGN STANDARDS	15 POINTS
FOUNTAIN IN SCM	4 POINTS
ON-STREET PUBLIC PARKING	4 POINTS
IPEMA CERTIFIED PLAYGROUND	4 POINTS
PUBLIC ART	4 POINTS
CONSERVATION OF OPEN SPACE BEYOND REQUIREMENT	4 POINTS

OPEN SPACE DATA

SEATING AREA	PROPOSED	0,004 3F			
		1 TABLE / 1,700 SF (6,864 / 1,700 SF = 4 TABLES MIN.) 1 SEAT /215 SF (6864 / 215 SF = 32 SEATS MIN.)			
		60 SF OF SHADED AREA / TABLE (60 X 4 = 240 SF MIN.)			
PLAYGROUND AREA	PROPOSED	7,650 SF			
		* PLAY AREA REQUIREMENTS CAN BE WITH A COMBINATION OF PLAY STRUCTURES, NATURAL PLAY, AND PLAY LAWN. (MIN. OF 1 PLAY STRUCTURE WITHIN PLAY AREA)			
		2 LF OF SEATING / 450 SF (7,650 / 450 SF = 17 LF TOTAL) (3 X 6' BENCHES = 18 LF)			

SITE DATA

• •					
SITE AREA	GROSS AREA	A: 24.5 AC			
EXISTING ZONING	RURAL TRAN	ISITION (RT)			
PROPOSED ZONING	GR3 - PUD	GR3 - PUD			
WATERSHED CLASSIFICATION	LOWER NEU	LOWER NEUSE RIVER			
RIVER BASIN	NEUSE				
FEMA DATA	FIRM PANEL	#3720173400K DATED 7/19/2022			
EXISTING USE	VACANT				
PROPOSED USE	SFD				
DENSITY	50 SFD UNIT	S / 24.50 = 2.04 DU/AC			
SETBACKS	PROPOSED	FRONT YARD: 18' (25' FOR FACE OF GARAGE)			
(SFD FRONT LOAD)	(PER PUD)	CORNER YARD: 10'			
		SIDE YARD: 5'			
		REAR YARD: 20'			
SETBACKS	PROPOSED	FRONT YARD: 10' (20' MIN. DRIVEWAY LENGTH)			
(SFD REAR LOAD)	(PER PUD)	CORNER YARD: 10'			
		SIDE YARD: 4'			
		REAR YARD: 15'			
PARKING (SFD)	REQUIRED	2/UNIT x 50 UNITS = 100 SPACES			
	PROPOSED	100 GARAGE SPACES			
		100 DRIVEWAY SPACES			
		200 TOTAL SPACES			
ON-STREET (STREET "B")	PROPOSED	14 SPACES			
KIOSK/PLAYGROUND	PROPOSED	14 SPACES			
PASSIVE OPEN SPACE	REQUIRED	1.045 AC			
	PROPOSED	1.91 AC			
ACTIVE OPEN SPACE	REQUIRED	1.045 AC			
	PROPOSED	0.22 AC ACTIVE OPEN SPACE AREAS			
		0.86 AC GREENWAY (1,263 LF x 30' ESMT = 37,890 SF)			
		1.08 AC TOTAL			
		(SEE OPEN SPACE PROGRAMMING TABLE ON SHEET C2.00)			
TOTAL OPEN SPACE	REQUIRED	2.09 AC			
	PROPOSED	3.10 AC			
TREE SAVE	REQUIRED	2.14 AC			
	PROPOSED	11.12 AC			
CONNECTIVITY	REQUIRED	1.4			
	PROPOSED	1.33			

SHEET INDEX

C1.01	EXISTING CONDITIONS
C1.02	EXISTING CONDITIONS
C2.00	OVERALL SITE PLAN
C2.01	SITE PLAN AREA "A"
C2.02	SITE PLAN AREA "B"
C2.10	PAVEMENT MARKING AND SIGNAGE PLAN AREA "A"
C2.11	PAVEMENT MARKING AND SIGNAGE PLAN AREA "B"
C3.00	OVERALL UTILITY PLAN
C3.01	UTILITY PLAN AREA "A"
C3.02	UTILITY PLAN AREA "B"
C8.00	TYPICAL SECTIONS
L5.00	LANDSCAPE PLAN AREA "A"
L5.01	LANDSCAPE PLAN AREA "B"
L5.02	LANDSCAPE DETAILS
L6.00	OVERALL LIGHTING PLAN

CONDITIONS OF APPROVAL:

A PETITION FOR ANNEXATION INTO THE CITY LIMITS SHALL BE SUBMITTED IN ACCORDANCE WITH CITY COUNCIL POLICY FOR EXTENSION OF UTILITY SERVICE TO PROPERTIES CURRENTLY OUTSIDE OF THE CITY LIMITS

CONSTRUCTION DRAWINGS MUST BE APPROVED BY THE CITY OF RALEIGH PUBLIC UTILITIES DEPARTMENT FOR ALL PUBLIC WATER, PUBLIC SEWER AND/OR PRIVATE SEWER EXTENSIONS PRIOR TO MAP RECORDATION.

A PLAT MUST BE RECORDED AT THE WAKE COUNTY REGISTER OF DEEDS OFFICE FOR ALL UTILITY EASEMENT DEDICATIONS

A PLAT MUST BE RECORDED FOR ALL NECESSARY OFFSITE RIGHT-OF-WAY TO ACCOMMODATE FUTURE WATERLINE CONSTRUCTION



CONTACT

TYLER PROBST, PE probst@mcadamsco.com PHONE: 919. 287. 0844

CLIENT


CAROLINA DEVELOPMENT GROUP, LLC 10136 MIZNER LANE RALEIGH, NC MARK PURYEAR PHONE: 919. 931. 2300

The John R. McAdams Company, Inc

2905 Meridian Parkway Durham, NC 27713

phone 919. 361. 5000 fax 919. 361. 2269 license number: C-0293, C-187

PROJECT DIRECTORY

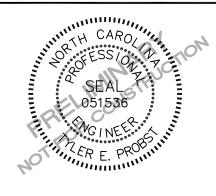

REVISIONS

1 09. 30. 2022 REV PER DRC COMMENT
2 11. 04. 2022 REV PER PUBLIC HEARING
3
4

MASTER PLAN FOR:

RIVER POINTE

105 AND 107 COLCHESTER DRIVE KNIGHTDALE, NC 27545 PROJECT NUMBER: CDV21001

VICINITY MAP

PRELIMINARY DRAWING - NOT RELEASED FOR CONSTRUCTION



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ELECTRIC METER

ELECTRIC BOX

GUY WIRE

CLEAN OUT SEWER MANHOLE TELEPHONE PEDESTAL AIR CONDITIONER

—

В

ELECTRIC TRANSFORMER

ELECTRIC PEDESTAL

ELECTRIC HANDHOLE

POWER/UTILITY POLE

----- UE ------

----- FO ------

----- UNK -----

_____ UT _____

UNDERGROUND ELECTRIC LINE

UNKNOWN UTILITY

PRELIMINARY DRAWING - NOT RELEASED FOR CONSTRUCTION

OVERHEAD ELECTRIC LINE

UNDERGROUND FIBER OPTIC CABLE

UNDERGROUND TELEPHONE CABLE

PROJECT NO. CDV21001 FILENAME CDV21001-C1 CHECKED BY RTF DRAWN BY SCALE 1"=50' 8/10/2022 SHEET

EXISTING CONDITIONS AREA "A"



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COLCHESTER DRIVE EXISTING CONDITIONTOWNS 105 AND 107 COLCHESTER DRIVE WAN OF KNIGHTDALE, WAKE COUNTY, NORTH CAROLINA

REVISIONS

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PLAN INFORMATION

PROJECT NO. CDV21001

FILENAME CDV21001-C1

CHECKED BY RTF

DRAWN BY DJM


SCALE 1"=50'

DATE 8/10/2022

SHEET

EXISTING CONDITIONS AREA "B"

C1.02

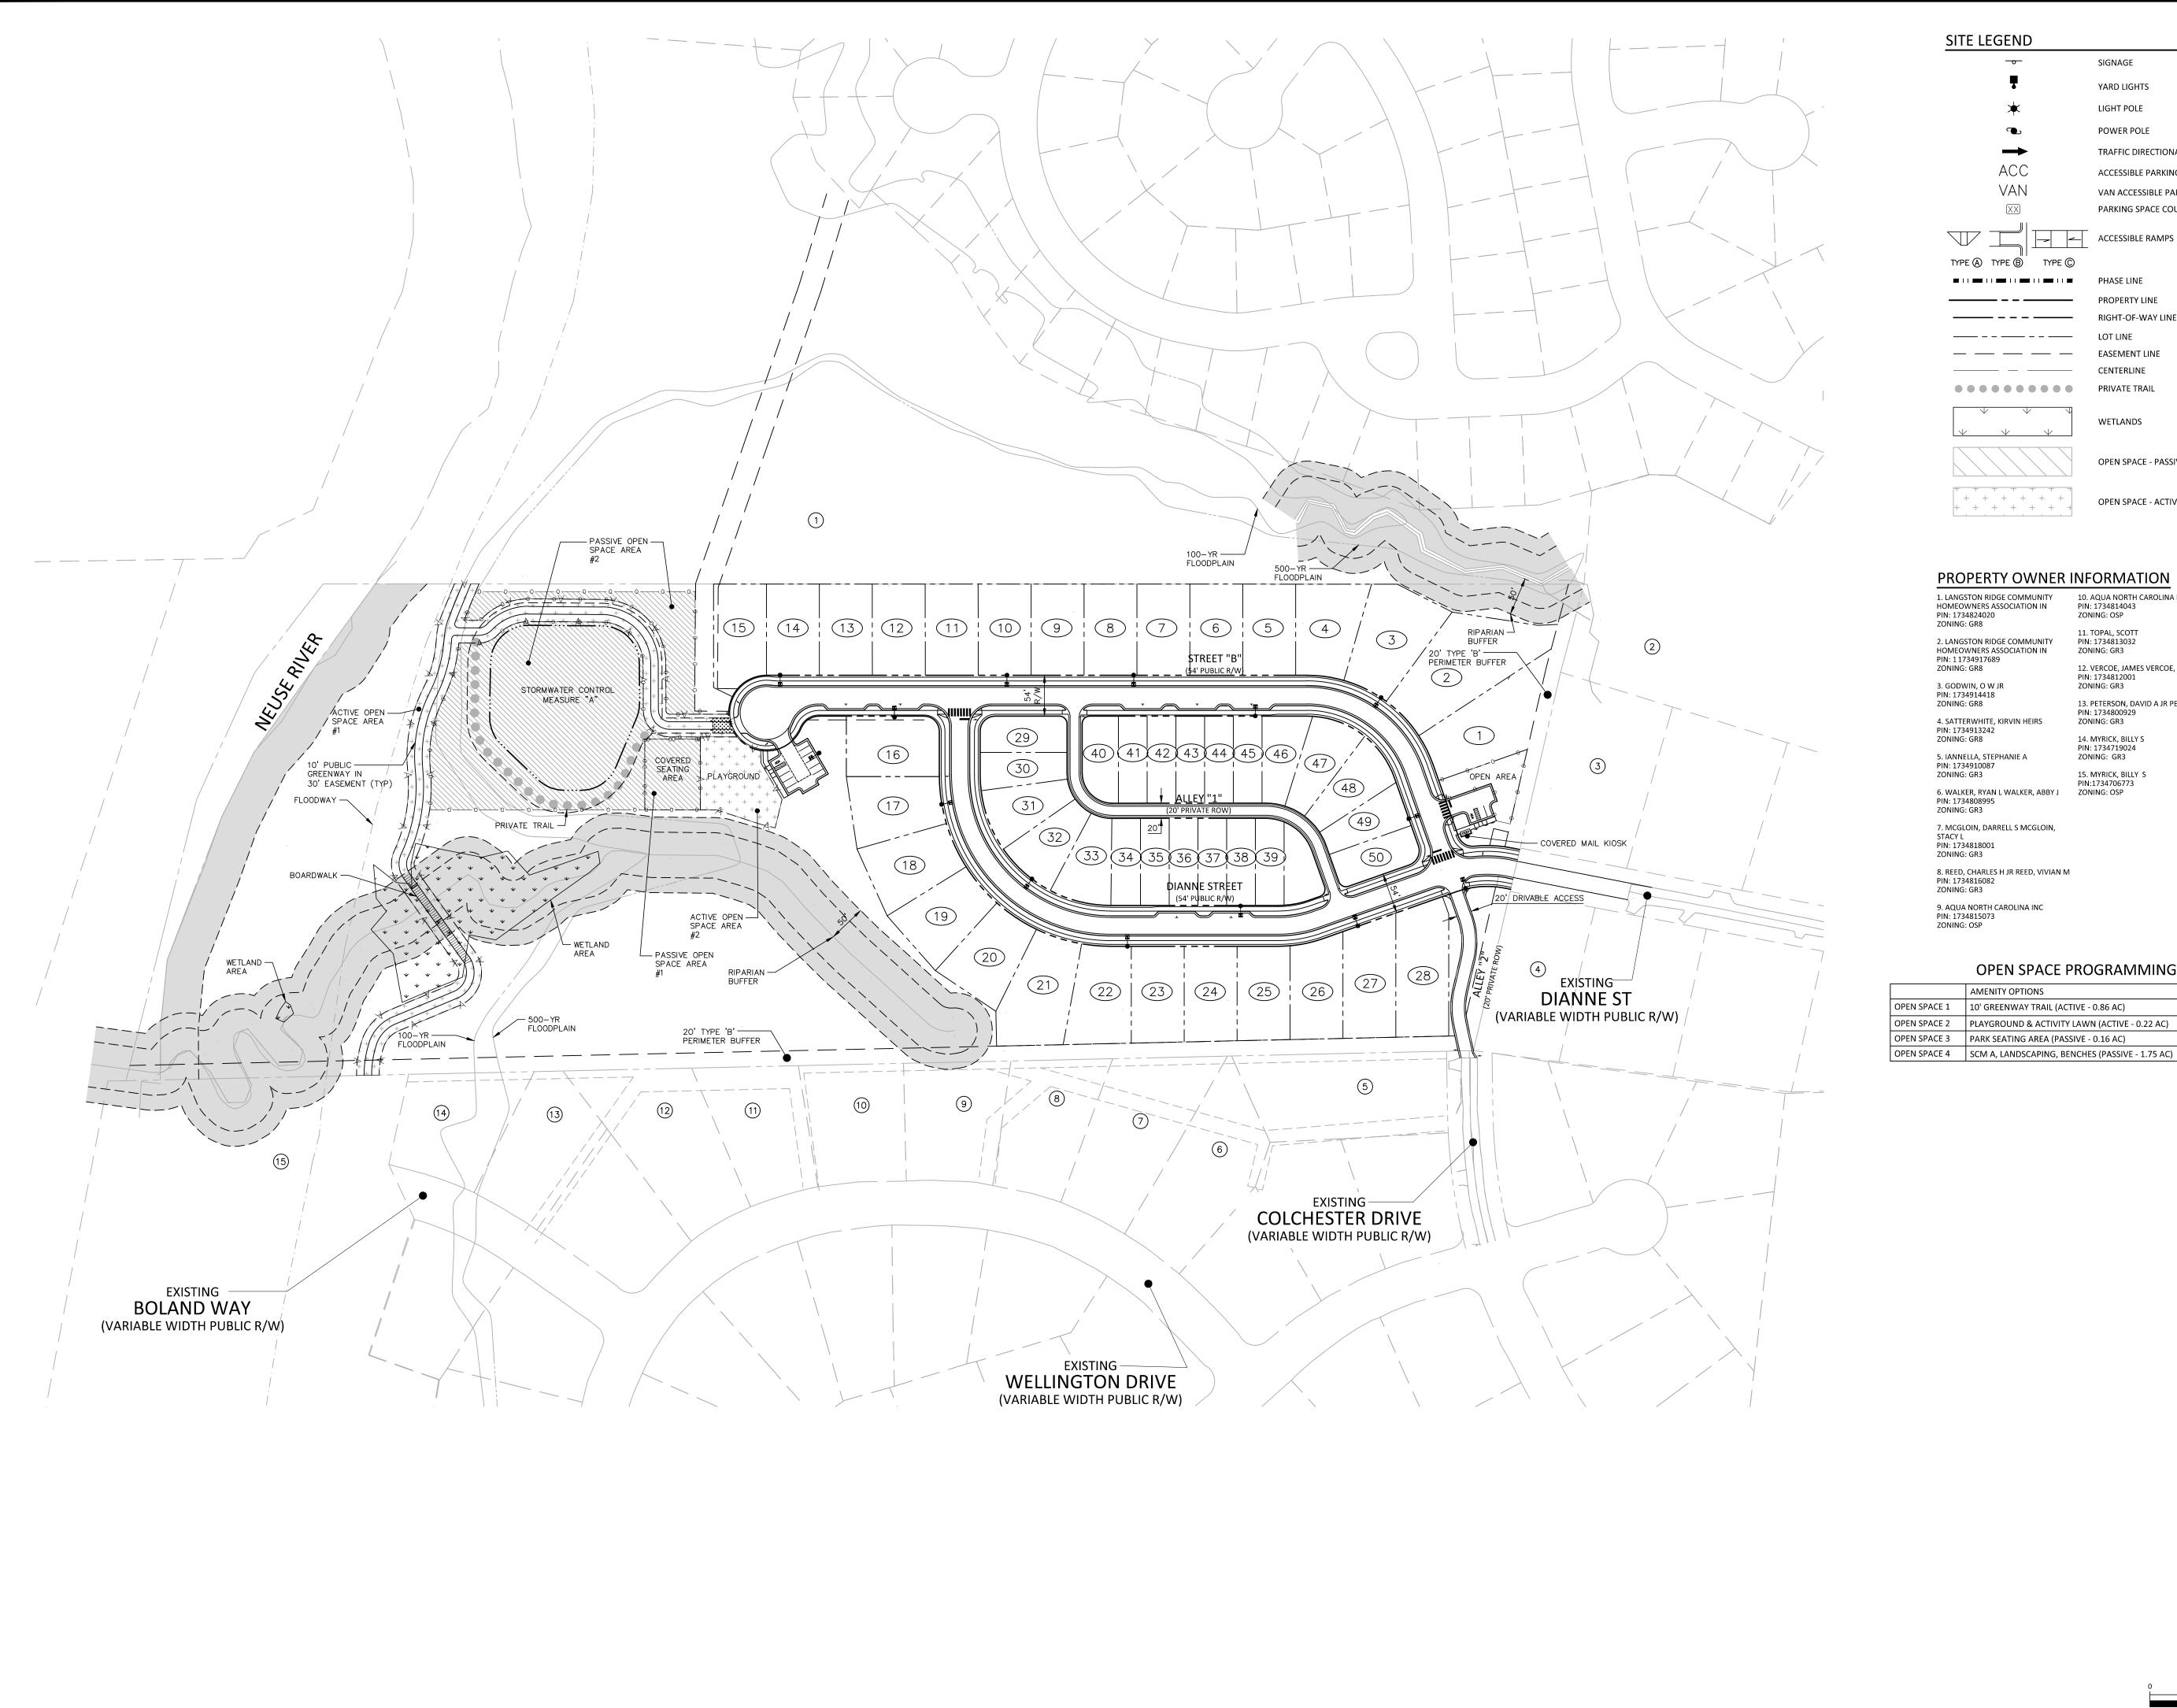

SIGNAGE YARD LIGHTS LIGHT POLE POWER POLE TRAFFIC DIRECTIONAL ARROW ACCESSIBLE PARKING STALL VAN VAN ACCESSIBLE PARKING STALL PARKING SPACE COUNT ACCESSIBLE RAMPS

PROPERTY LINE RIGHT-OF-WAY LINE ____ - - ___ LOT LINE

EASEMENT LINE CENTERLINE PRIVATE TRAIL WETLANDS

OPEN SPACE - PASSIVE

OPEN SPACE - ACTIVE

PROPERTY OWNER INFORMATION

10. AQUA NORTH CAROLINA INC PIN: 1734814043 ZONING: OSP 11. TOPAL, SCOTT PIN: 1734813032 ZONING: GR3 12. VERCOE, JAMES VERCOE, MELISSA

PIN: 1734812001 13. PETERSON, DAVID A JR PETERSON, SUSAN M PIN: 1734800929

4. SATTERWHITE, KIRVIN HEIRS ZONING: GR3 14. MYRICK, BILLY S PIN: 1734719024 ZONING: GR3 15. MYRICK, BILLY S

7. MCGLOIN, DARRELL S MCGLOIN,

8. REED, CHARLES H JR REED, VIVIAN M

OPEN SPACE PROGRAMMING

	AMENITY OPTIONS
OPEN SPACE 1	10' GREENWAY TRAIL (ACTIVE - 0.86 AC)
OPEN SPACE 2	PLAYGROUND & ACTIVITY LAWN (ACTIVE - 0.22 AC)
OPEN SPACE 3	PARK SEATING AREA (PASSIVE - 0.16 AC)



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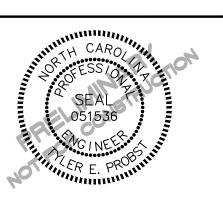
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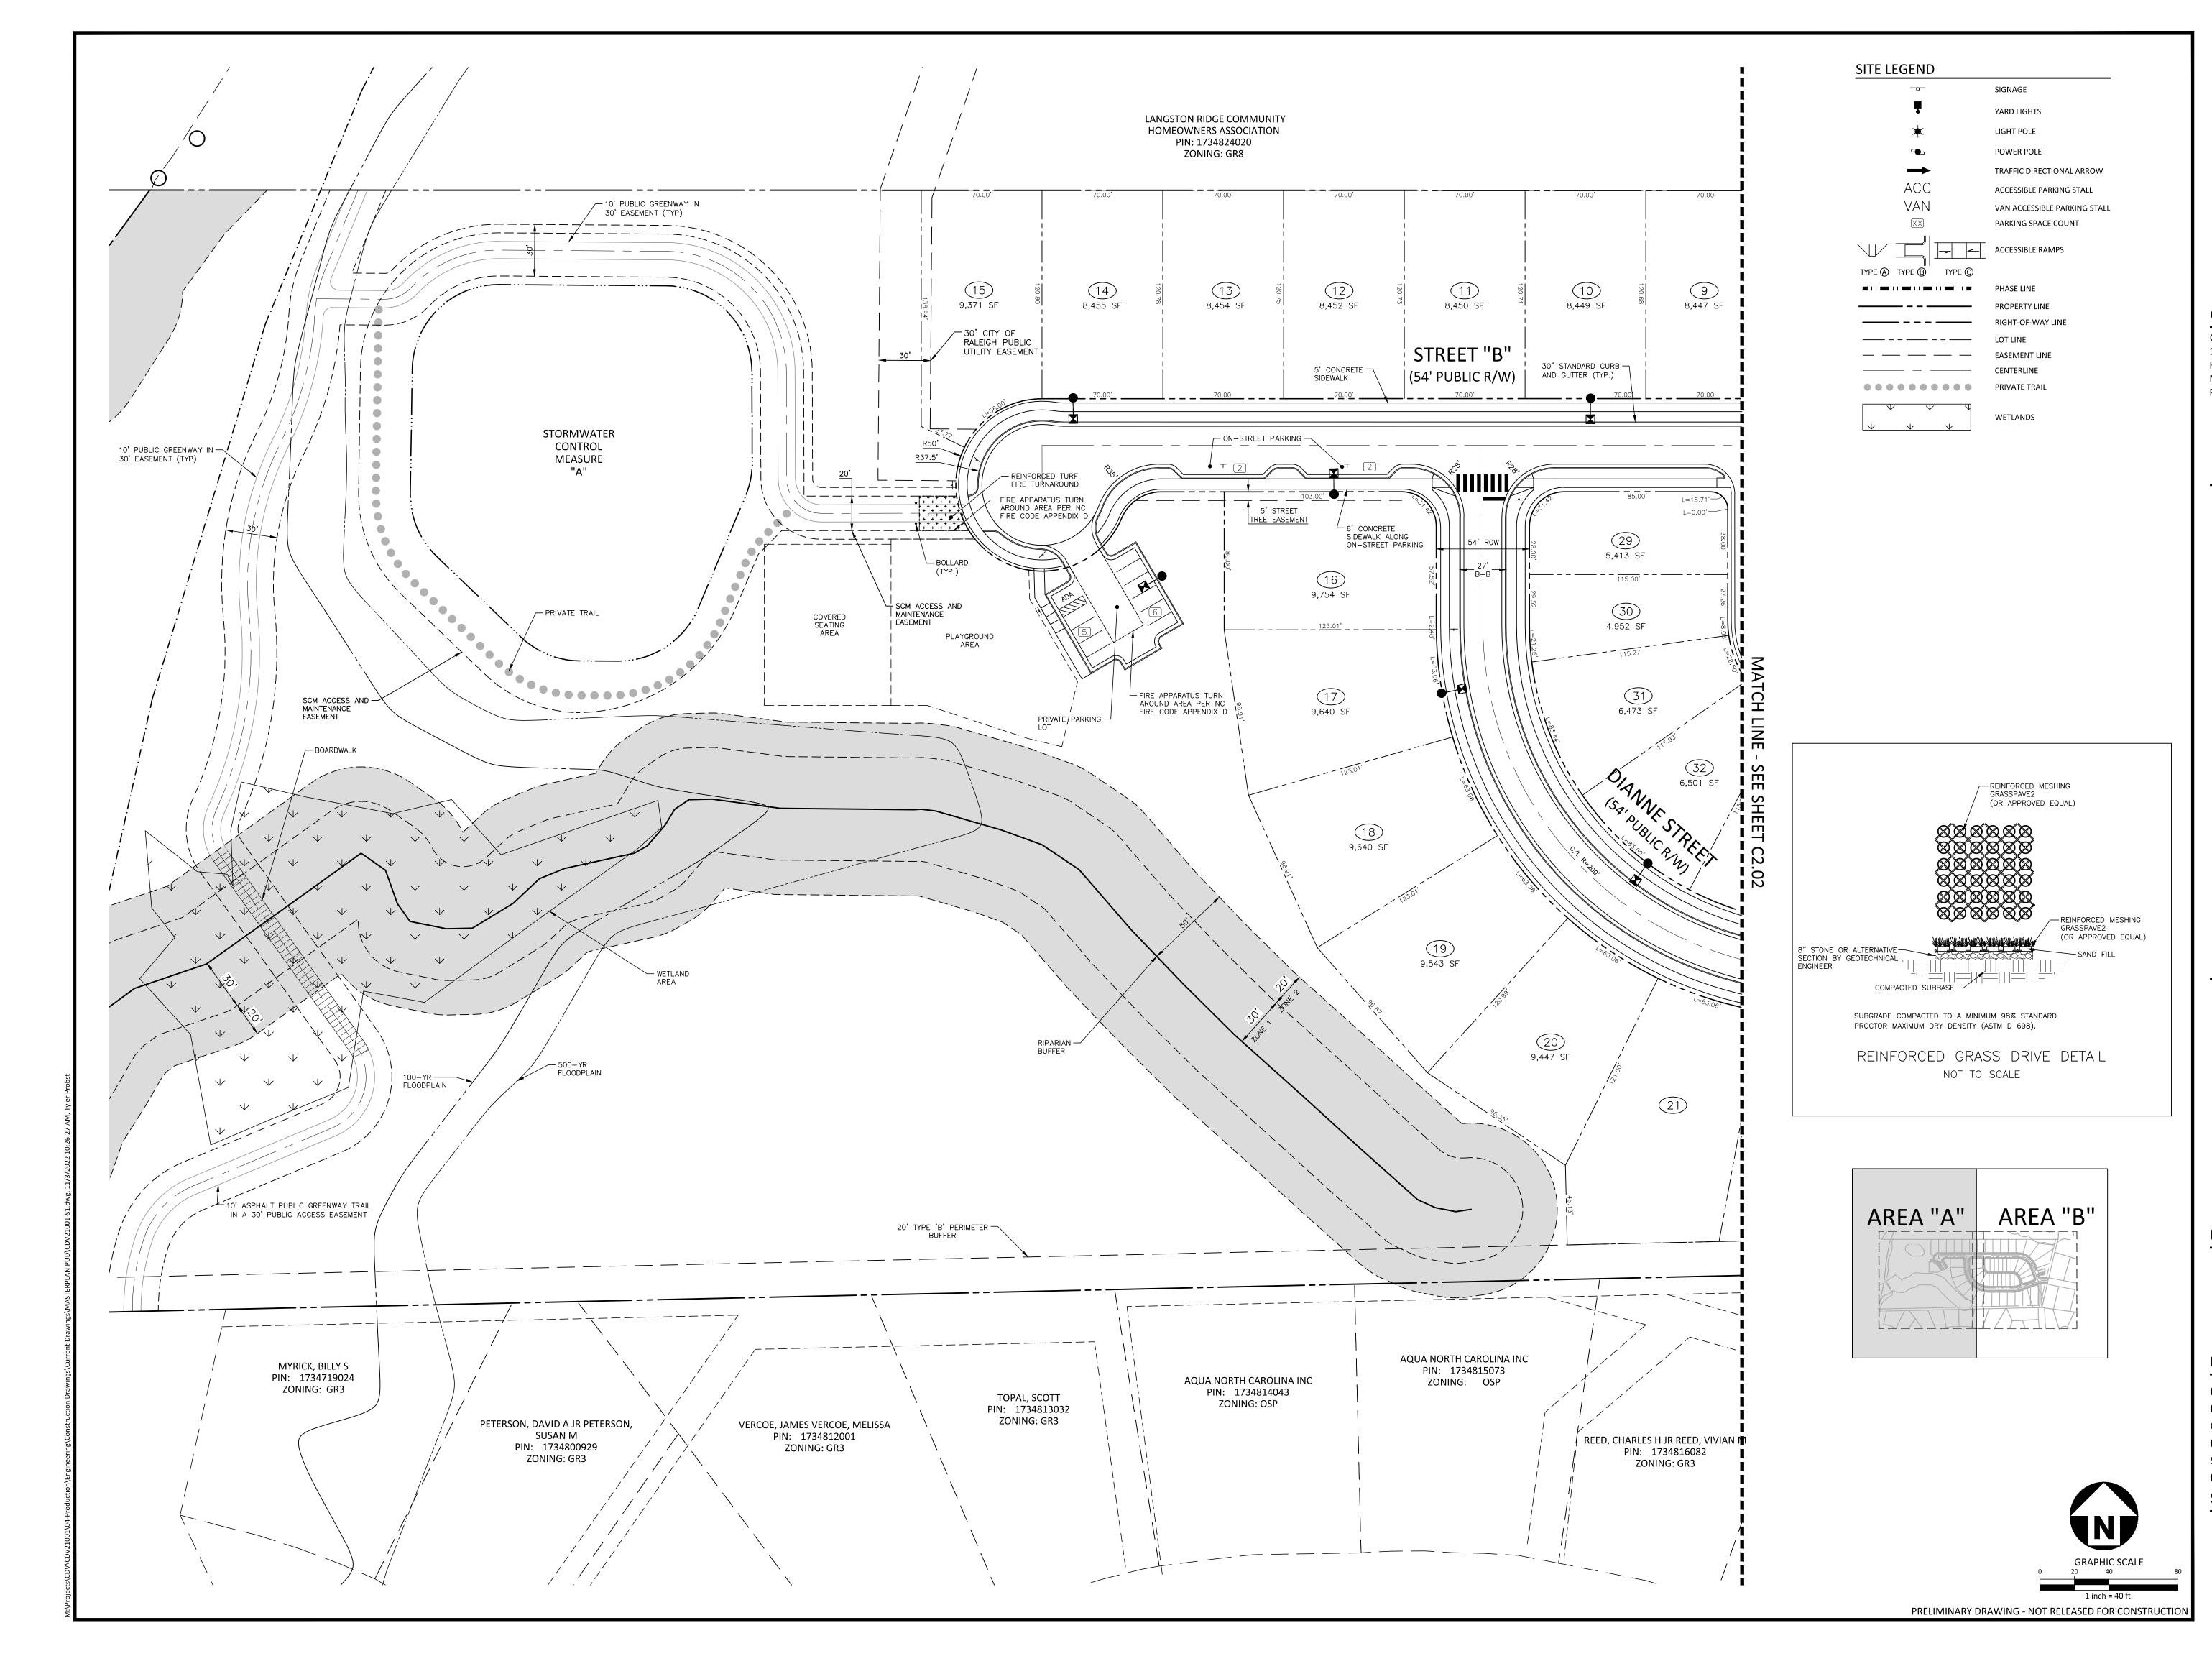
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1 09. 30. 2022 REV PER DRC COMMENT 2 11. 04. 2022 REV PER PUBLIC HEARING

PLAN INFORMATION

PROJECT NO. CDV21001 CDV21001-OAS1 FILENAME CHECKED BY DRAWN BY SCALE 1" = 100' DATE 08. 22. 2022

OVERALL SITE PLAN





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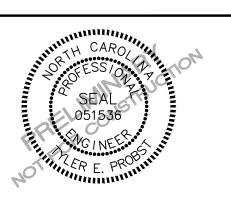
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KIVER POINTE MASTER PLAN 5 AND 107 COLCHESTER DRIV KNIGHTDALE, NC 27545



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FILENAME CDV21001-S1

CHECKED BY JCM

DRAWN BY RJF/CNM


SCALE 1" = 40'

DATE 08. 22. 2022

SHEET

SITE PLAN AREA "A"

C2.01

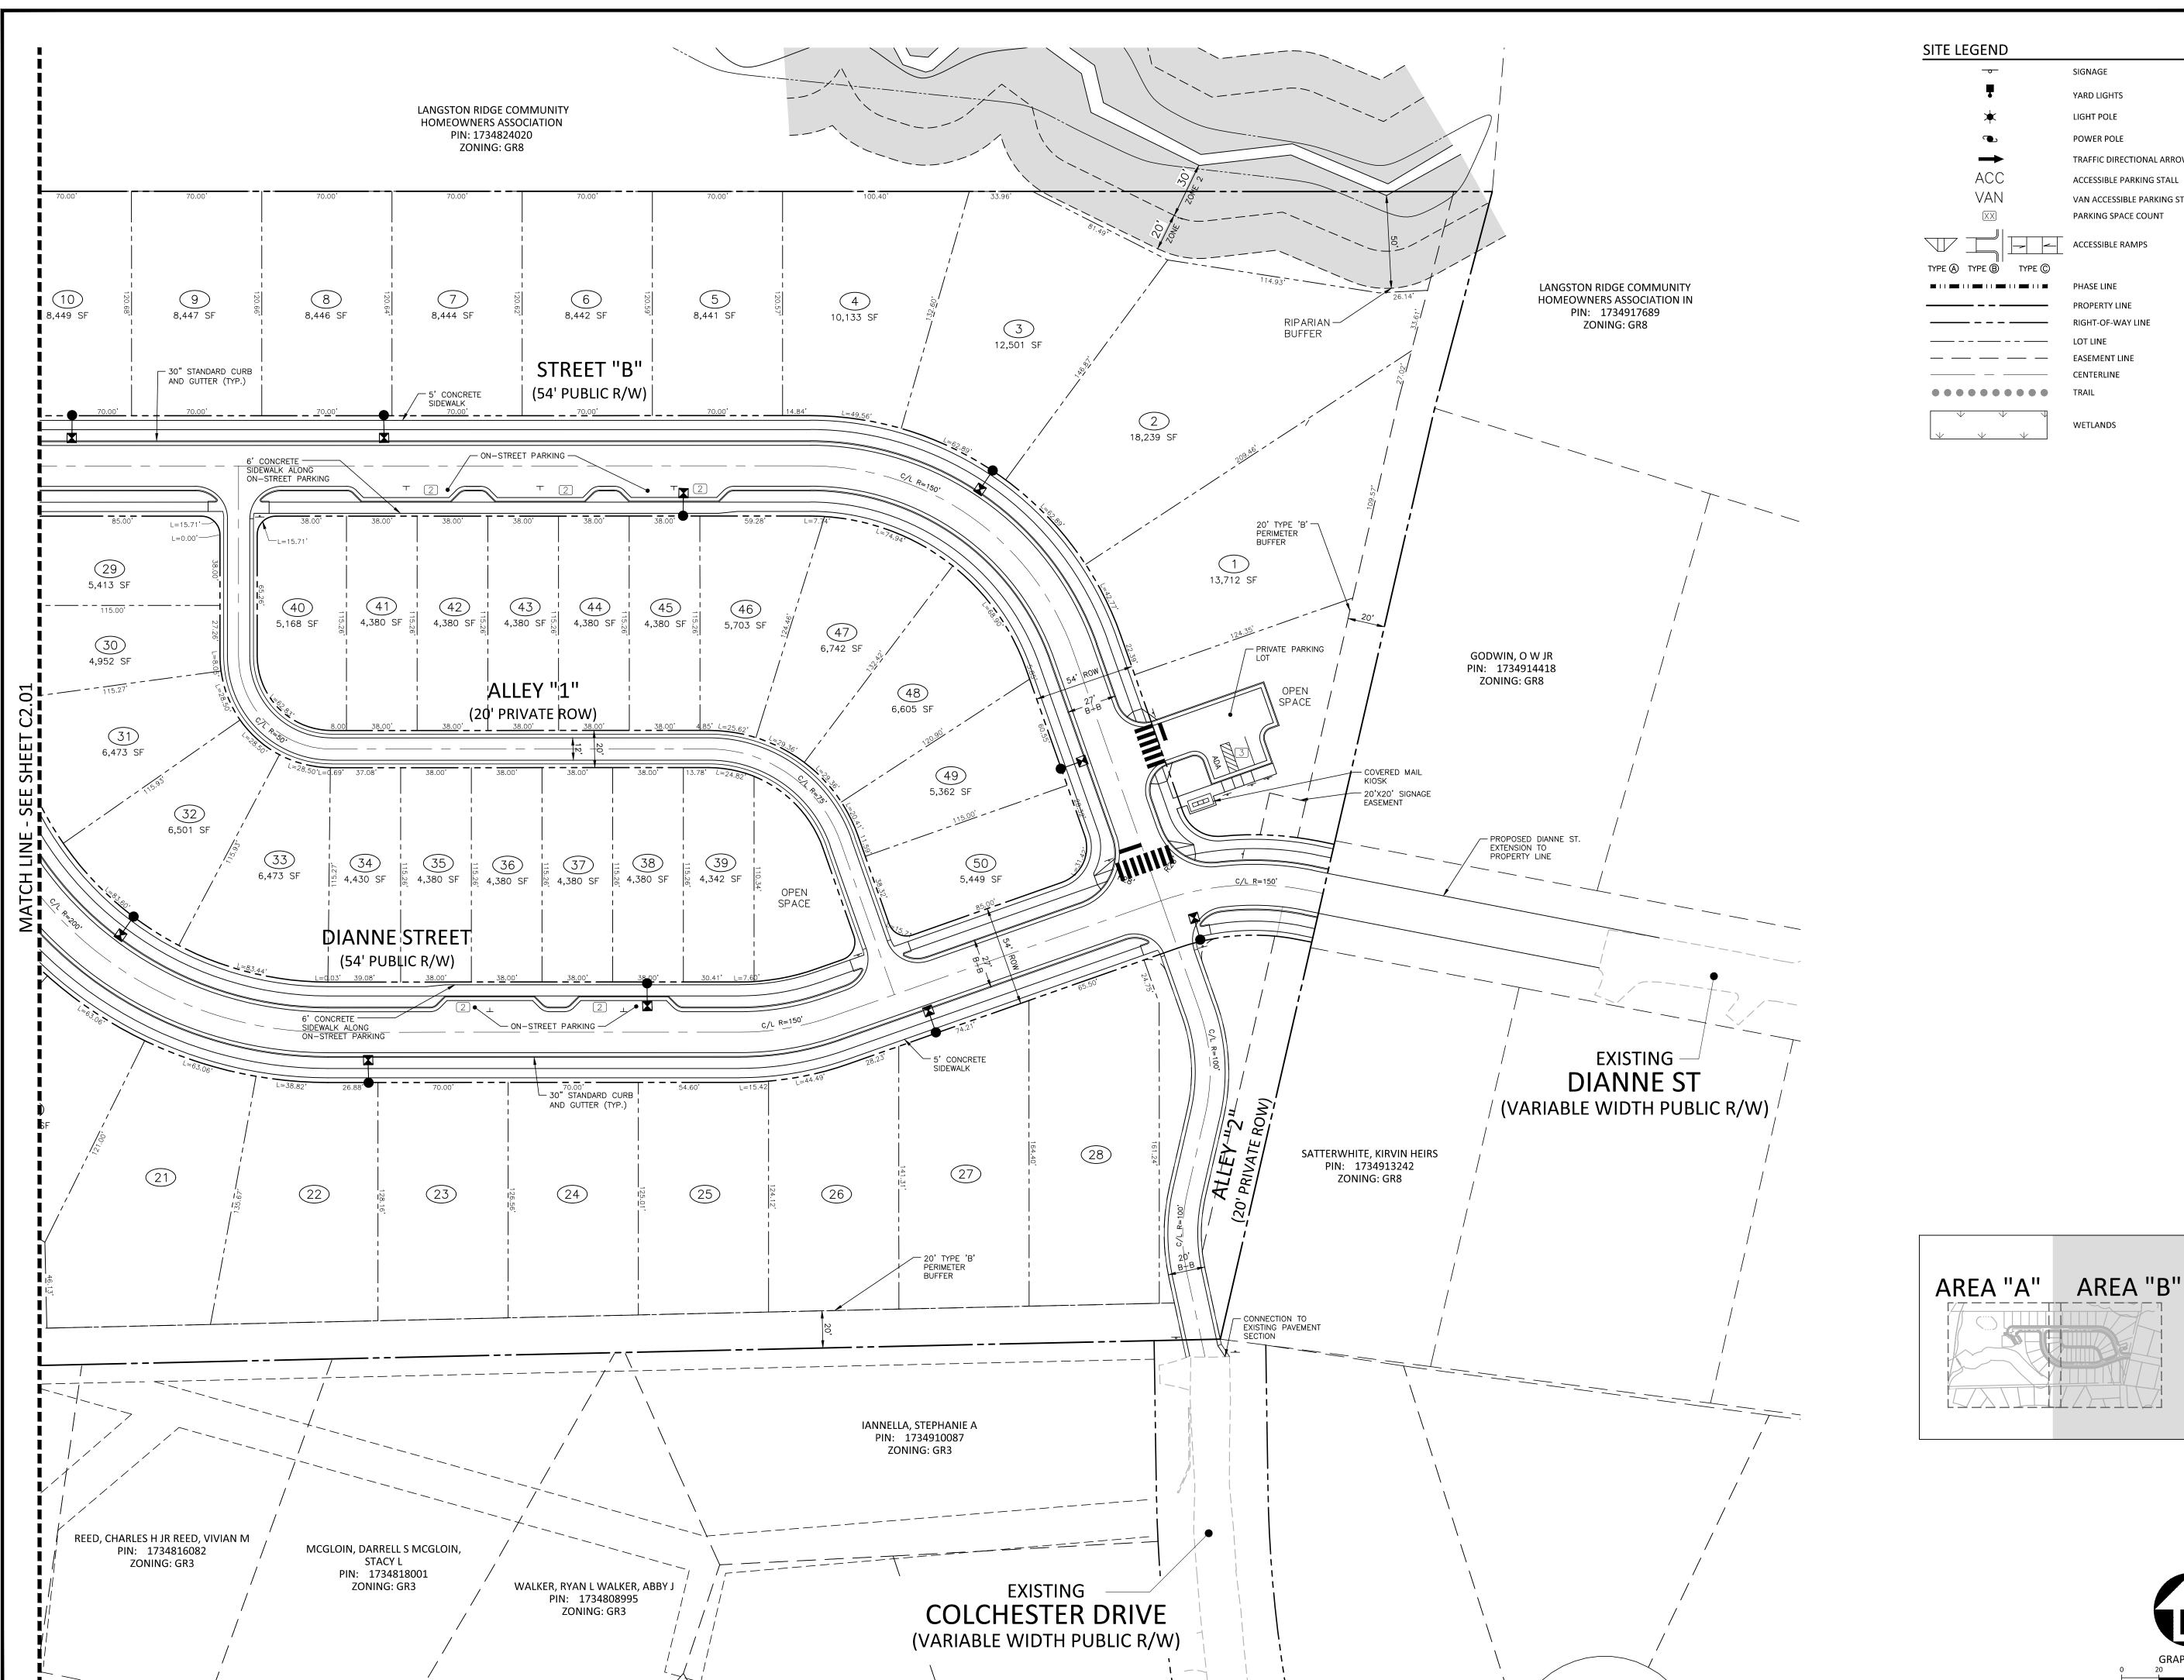

YARD LIGHTS

LIGHT POLE **POWER POLE**

TRAFFIC DIRECTIONAL ARROW ACCESSIBLE PARKING STALL VAN ACCESSIBLE PARKING STALL PARKING SPACE COUNT

ACCESSIBLE RAMPS

EASEMENT LINE CENTERLINE

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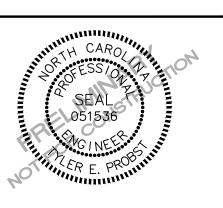
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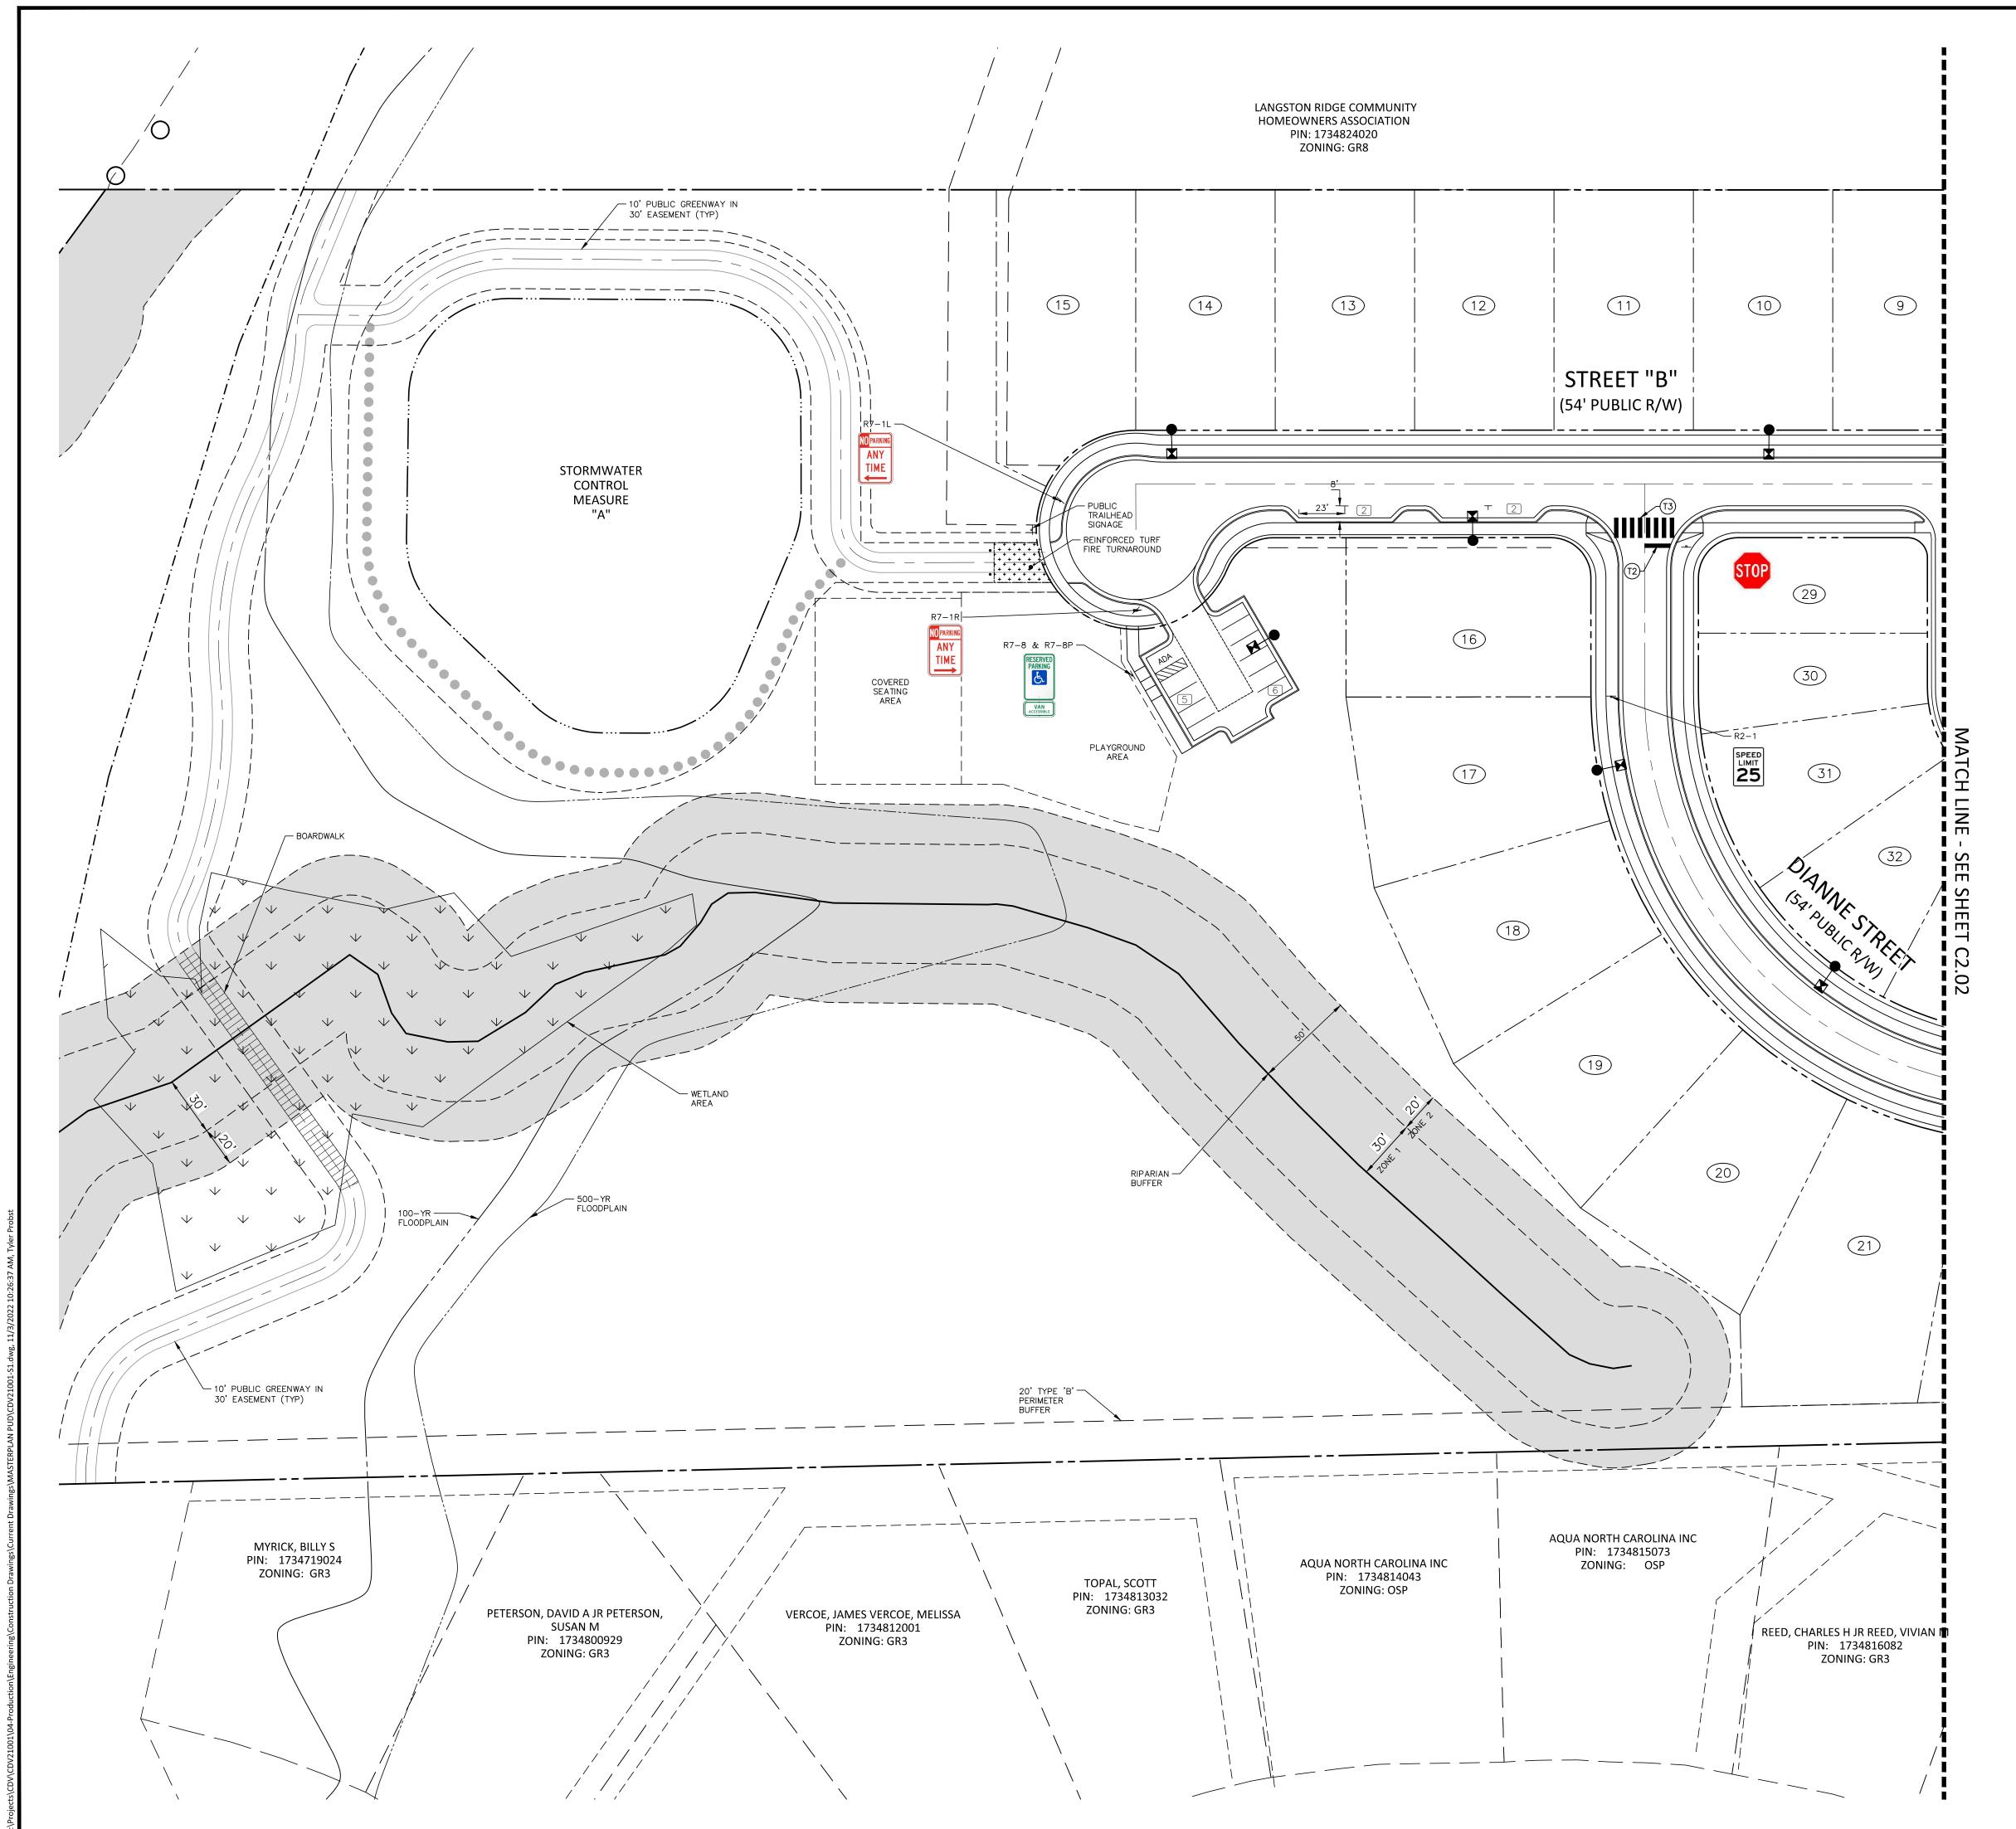
PROJECT NO. CDV21001 CDV21001-S1 FILENAME CHECKED BY DRAWN BY SCALE 1" = 40'

DATE SHEET

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SITE PLAN AREA "B"

08. 22. 2022



POSTED SPEED = 25 MPH DESIGN SPEED = 30 MPH

- 1. ALL NEW SIGNS WILL INCLUDE PRISMATIC SHEETING AND WILL CONFORM TO THE LATEST RETROREFLECTIVITY STANDARDS FOUND IN THE LATEST EDITION OF THE
- 2. ALL SIGNS MUST MEET MUTCD GUIDELINES FOR LETTER HEIGHT, LETTER CASE AND SIGN COLOR.

PAVEMENT MARKING LEGEND LANE LINES/MARKINGS


- T2 24" WHITE STOPBAR
- T3 24" WHITE CROSSWALK LINE (HIGH VISIBILITY)


SITE SIGN KEY







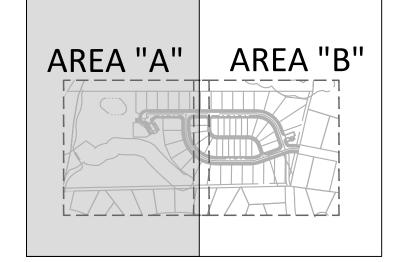

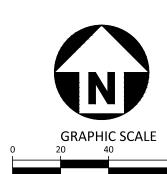

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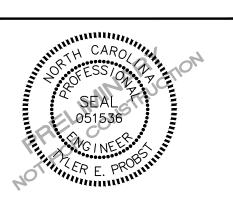
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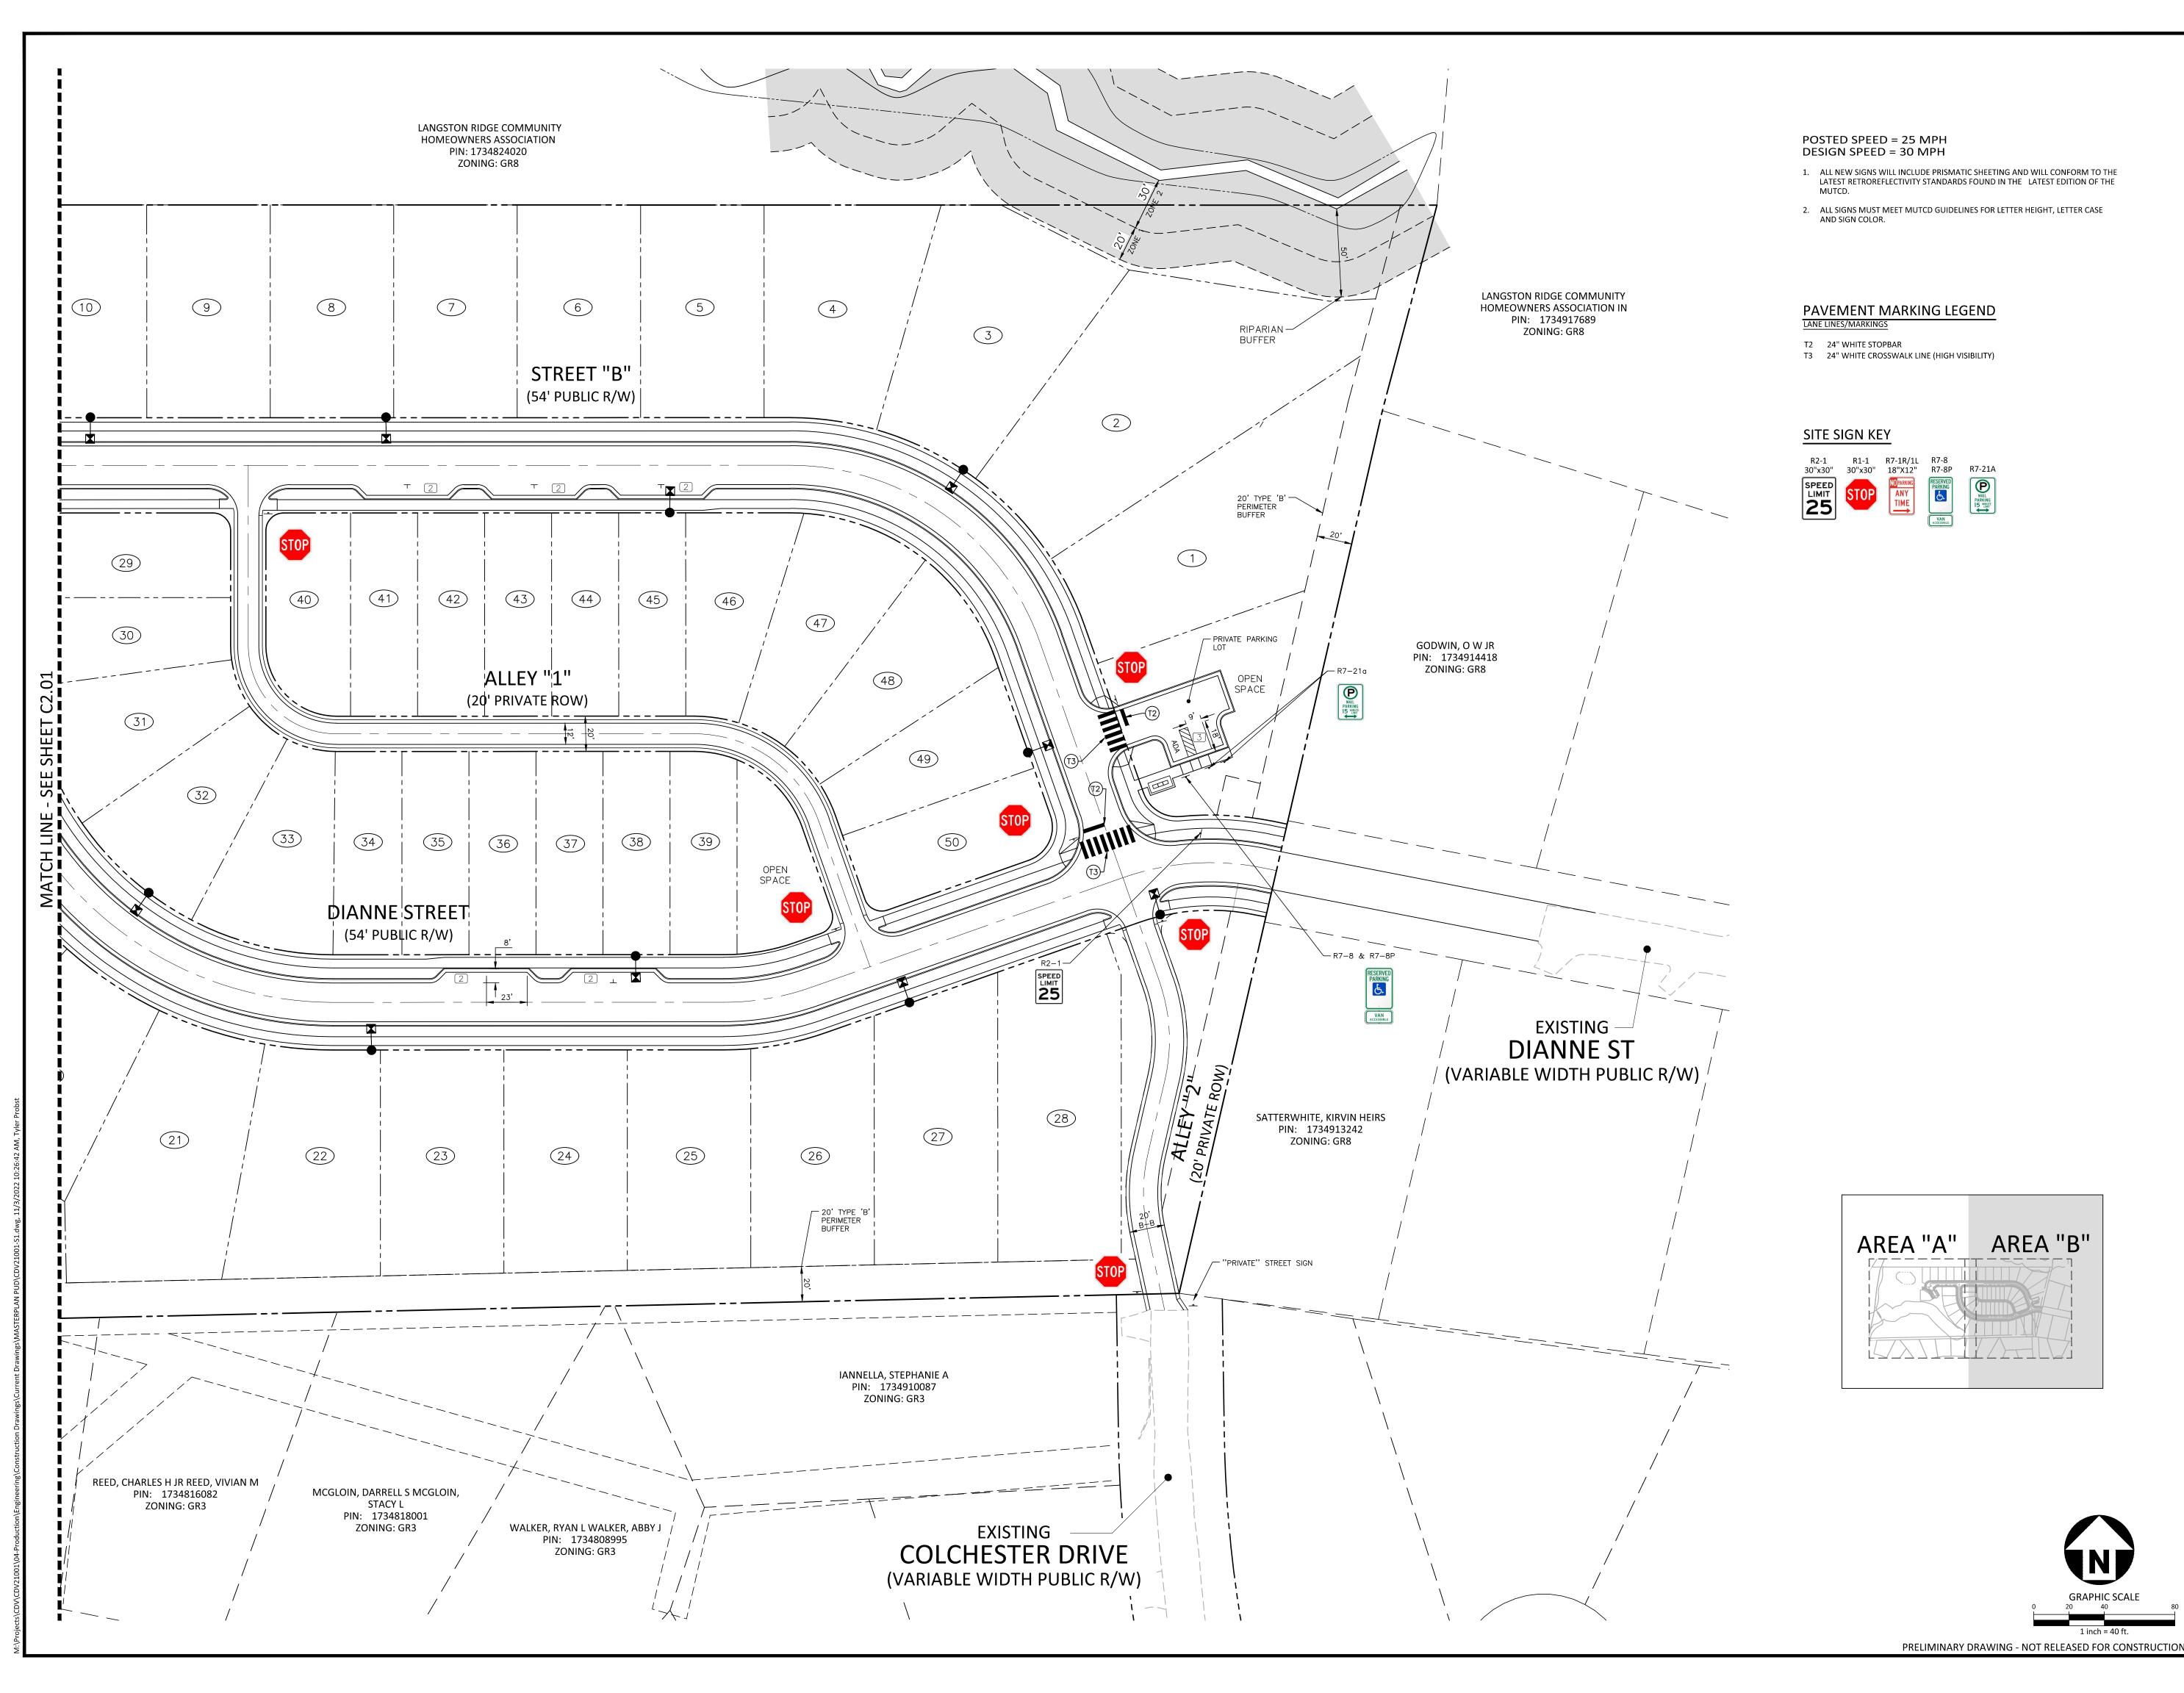
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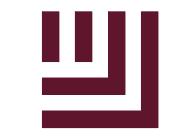
PLAN INFORMATION

PROJECT NO. CDV21001 CDV21001-S1 FILENAME CHECKED BY DRAWN BY 1" = 40' SCALE 08. 22. 2022 DATE

SHEET

PAVEMENT MARKING AND SIGNAGE PLAN AREA "A"





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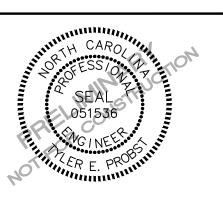
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MASTER PLAN MASTER PLAN S AND 107 COLCHESTER DRIV



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PLAN INFORMATION

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FILENAME CDV21001-S1

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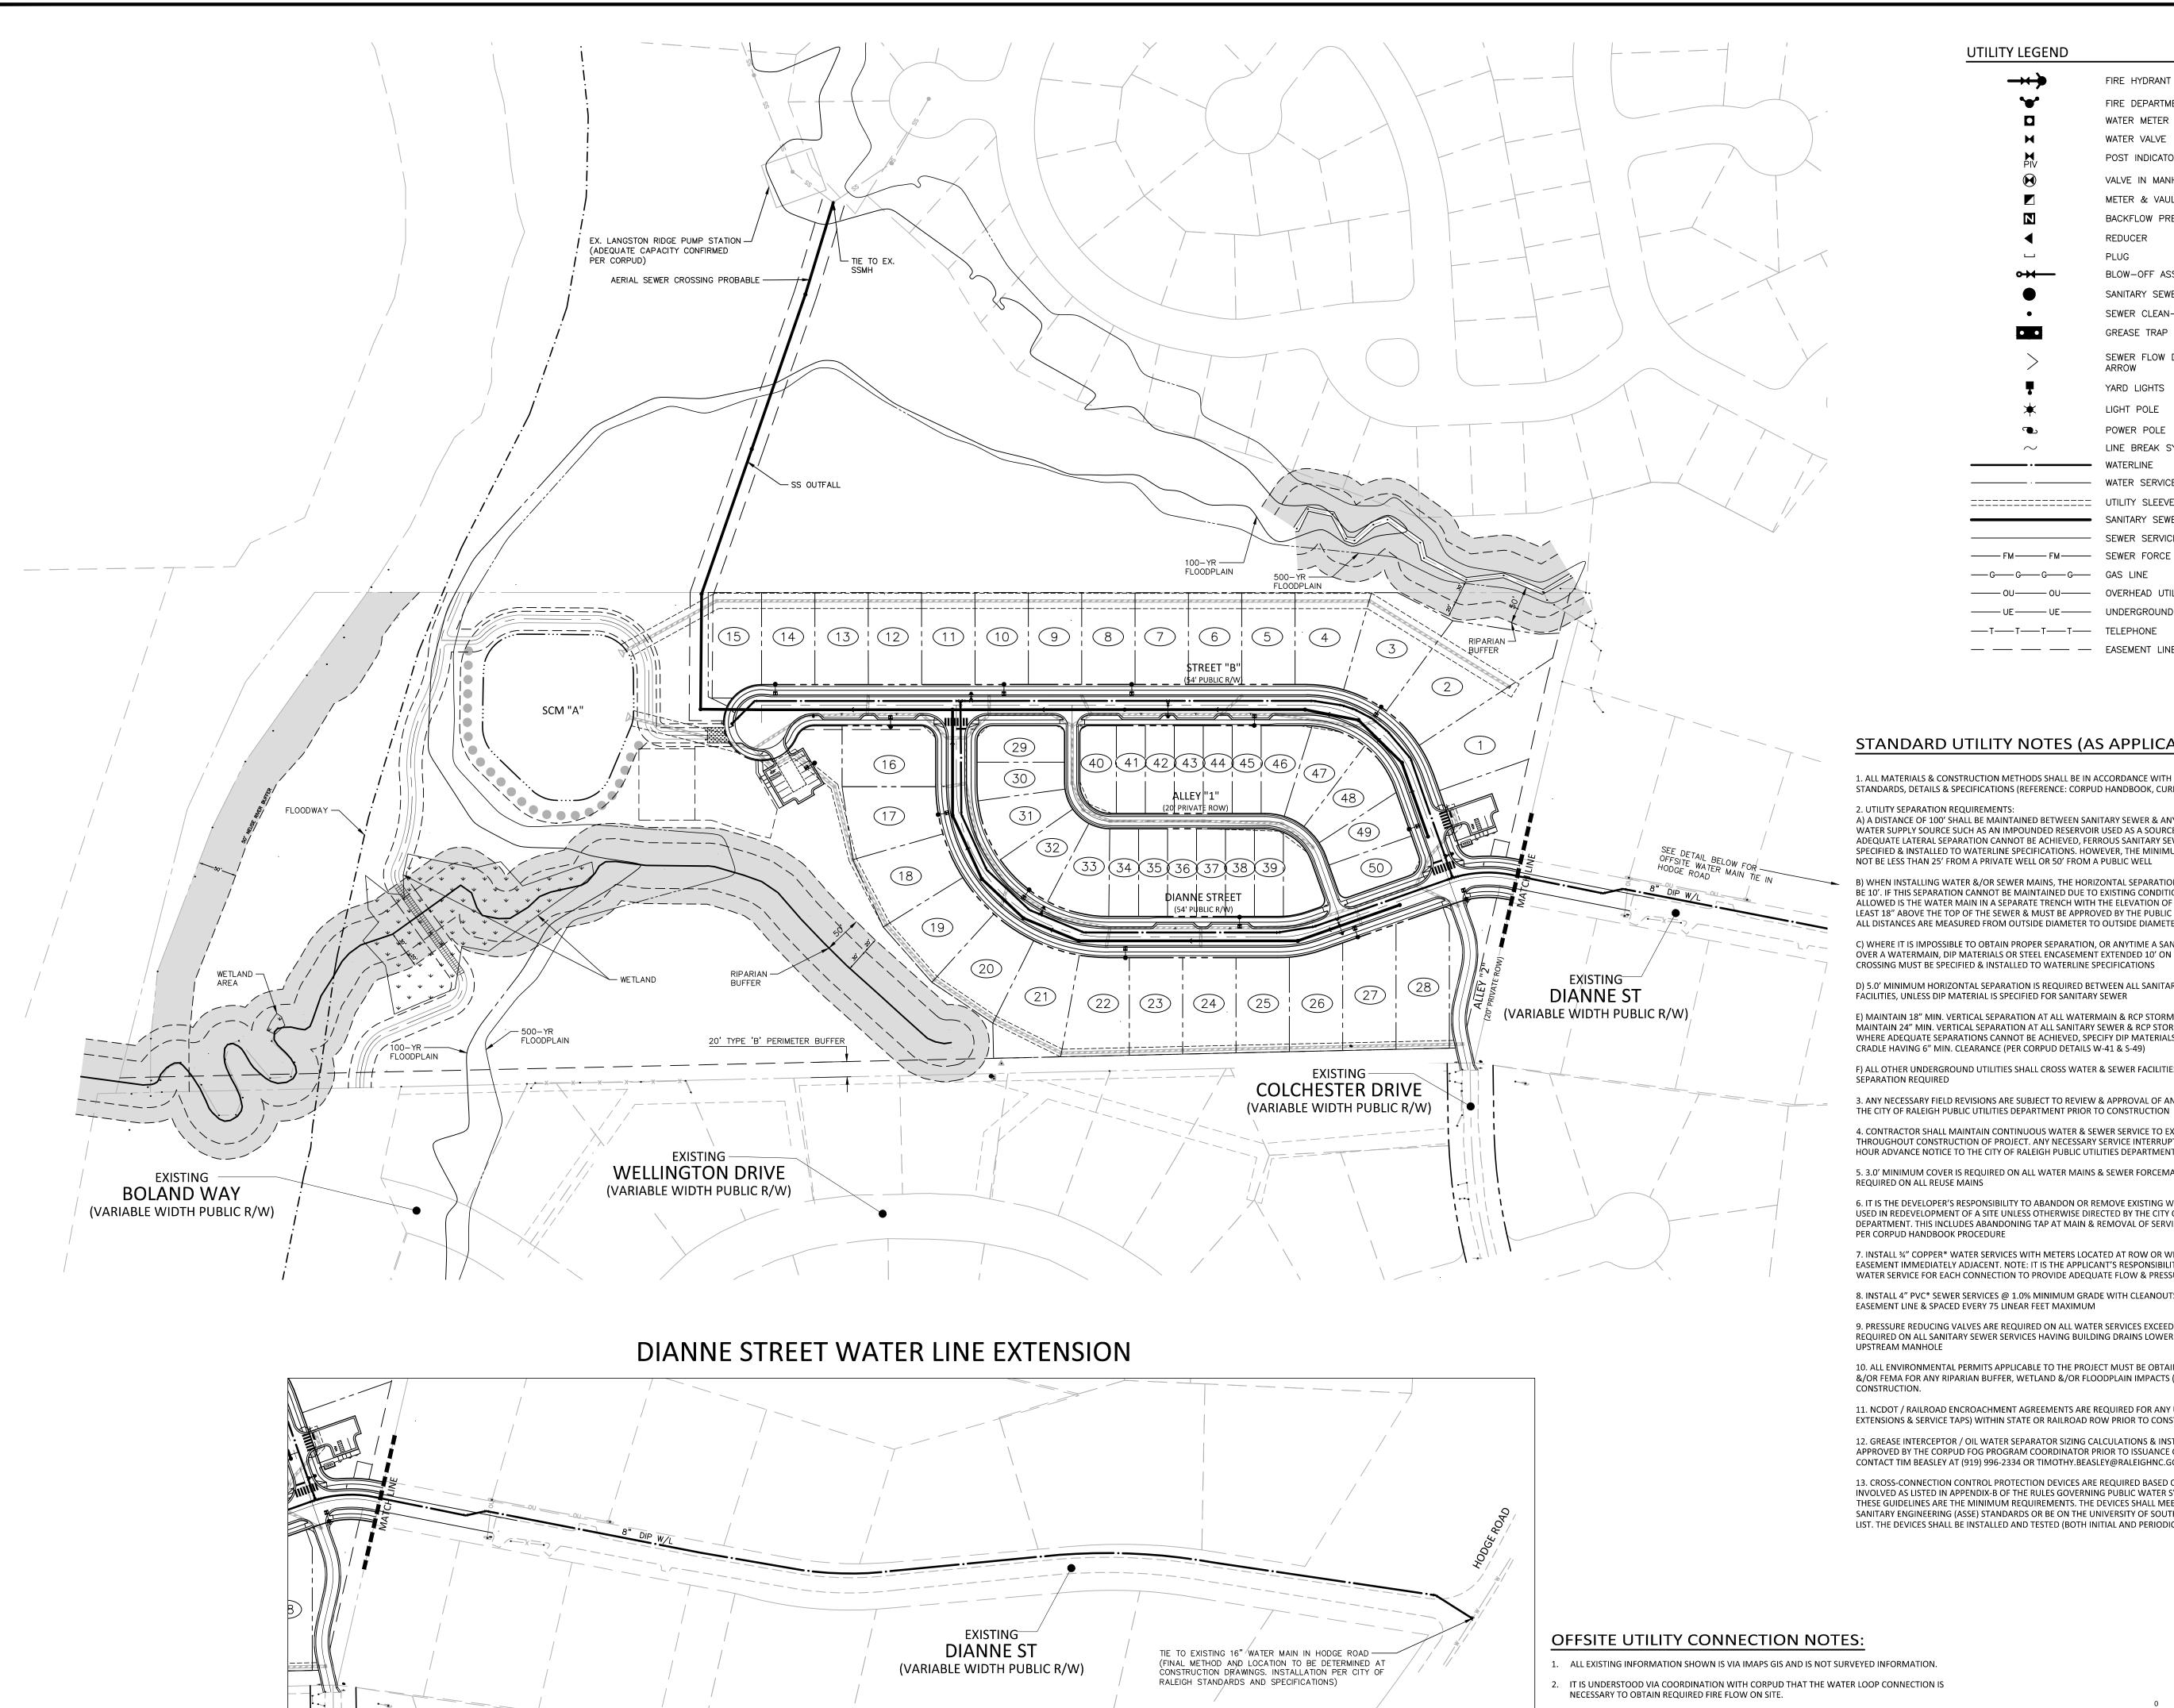
SCALE 1" = 40'

DATE 08. 22. 2022

SHEET

PAVEMENT MARKING AND SIGNAGE PLAN AREA "B"

C2.11



UTILITY LEGEND

FIRE HYDRANT ASSEMBLY FIRE DEPARTMENT CONNECTION (FDC) WATER METER WATER VALVE POST INDICATOR VALVE VALVE IN MANHOLE METER & VAULT BACKFLOW PREVENTER REDUCER PLUG BLOW-OFF ASSEMBLY SANITARY SEWER MANHOLE SEWER CLEAN-OUT GREASE TRAP SEWER FLOW DIRECTION YARD LIGHTS LIGHT POLE POWER POLE LINE BREAK SYMBOL WATERLINE WATER SERVICE LINE :_____ UTILITY SLEEVE SANITARY SEWER — SEWER SERVICE LINE ——G——G——GAS LINE —— UE—— UE— UNDERGROUND ELECTRIC —__T—_T—_T—_T TELEPHONE — — EASEMENT LINE

STANDARD UTILITY NOTES (AS APPLICABLE):

1. ALL MATERIALS & CONSTRUCTION METHODS SHALL BE IN ACCORDANCE WITH CITY OF RALEIGH DESIGN STANDARDS, DETAILS & SPECIFICATIONS (REFERENCE: CORPUD HANDBOOK, CURRENT EDITION)

A) A DISTANCE OF 100' SHALL BE MAINTAINED BETWEEN SANITARY SEWER & ANY PRIVATE OR PUBLIC WATER SUPPLY SOURCE SUCH AS AN IMPOUNDED RESERVOIR USED AS A SOURCE OF DRINKING WATER. IF ADEQUATE LATERAL SEPARATION CANNOT BE ACHIEVED. FERROUS SANITARY SEWER PIPE SHALL BE SPECIFIED & INSTALLED TO WATERLINE SPECIFICATIONS. HOWEVER, THE MINIMUM SEPARATION SHALL NOT BE LESS THAN 25' FROM A PRIVATE WELL OR 50' FROM A PUBLIC WELL

WHEN INSTALLING WATER &/OR SEWER MAINS, THE HORIZONTAL SEPARATION BETWEEN UTILITIES SHALL BE 10'. IF THIS SEPARATION CANNOT BE MAINTAINED DUE TO EXISTING CONDITIONS, THE VARIATION ALLOWED IS THE WATER MAIN IN A SEPARATE TRENCH WITH THE ELEVATION OF THE WATER MAIN AT LEAST 18" ABOVE THE TOP OF THE SEWER & MUST BE APPROVED BY THE PUBLIC UTILITIES DIRECTOR. ALL DISTANCES ARE MEASURED FROM OUTSIDE DIAMETER TO OUTSIDE DIAMETER

C) WHERE IT IS IMPOSSIBLE TO OBTAIN PROPER SEPARATION, OR ANYTIME A SANITARY SEWER PASSES OVER A WATERMAIN, DIP MATERIALS OR STEEL ENCASEMENT EXTENDED 10' ON EACH SIDE OF CROSSING MUST BE SPECIFIED & INSTALLED TO WATERLINE SPECIFICATIONS

D) 5.0' MINIMUM HORIZONTAL SEPARATION IS REQUIRED BETWEEN ALL SANITARY SEWER & STORM SEWER

E) MAINTAIN 18" MIN. VERTICAL SEPARATION AT ALL WATERMAIN & RCP STORM DRAIN CROSSINGS; MAINTAIN 24" MIN. VERTICAL SEPARATION AT ALL SANITARY SEWER & RCP STORM DRAIN CROSSINGS. WHERE ADEQUATE SEPARATIONS CANNOT BE ACHIEVED, SPECIFY DIP MATERIALS & A CONCRETE

F) ALL OTHER UNDERGROUND UTILITIES SHALL CROSS WATER & SEWER FACILITIES WITH 18" MIN. VERTICAL

3. ANY NECESSARY FIELD REVISIONS ARE SUBJECT TO REVIEW & APPROVAL OF AN AMENDED PLAN &/OR PROFILE BY

4. CONTRACTOR SHALL MAINTAIN CONTINUOUS WATER & SEWER SERVICE TO EXISTING RESIDENCES & BUSINESSES THROUGHOUT CONSTRUCTION OF PROJECT. ANY NECESSARY SERVICE INTERRUPTIONS SHALL BE PRECEDED BY A 24 HOUR ADVANCE NOTICE TO THE CITY OF RALEIGH PUBLIC UTILITIES DEPARTMENT

5. 3.0' MINIMUM COVER IS REQUIRED ON ALL WATER MAINS & SEWER FORCEMAINS. 4.0' MINIMUM COVER IS REQUIRED ON ALL REUSE MAINS

6. IT IS THE DEVELOPER'S RESPONSIBILITY TO ABANDON OR REMOVE EXISTING WATER & SEWER SERVICES NOT BEING USED IN REDEVELOPMENT OF A SITE UNLESS OTHERWISE DIRECTED BY THE CITY OF RALEIGH PUBLIC UTILITIES DEPARTMENT. THIS INCLUDES ABANDONING TAP AT MAIN & REMOVAL OF SERVICE FROM ROW OR EASEMENT

7. INSTALL ¾" COPPER* WATER SERVICES WITH METERS LOCATED AT ROW OR WITHIN A 2'X2' WATERLINE EASEMENT IMMEDIATELY ADJACENT. NOTE: IT IS THE APPLICANT'S RESPONSIBILITY TO PROPERLY SIZE THE WATER SERVICE FOR EACH CONNECTION TO PROVIDE ADEQUATE FLOW & PRESSURE

8. INSTALL 4" PVC* SEWER SERVICES @ 1.0% MINIMUM GRADE WITH CLEANOUTS LOCATED AT ROW OR EASEMENT LINE & SPACED EVERY 75 LINEAR FEET MAXIMUM

9. PRESSURE REDUCING VALVES ARE REQUIRED ON ALL WATER SERVICES EXCEEDING 80 PSI; BACKWATER VALVES ARE REQUIRED ON ALL SANITARY SEWER SERVICES HAVING BUILDING DRAINS LOWER THAN 1.0' ABOVE THE NEXT


10. ALL ENVIRONMENTAL PERMITS APPLICABLE TO THE PROJECT MUST BE OBTAINED FROM NCDWQ, USACE &/OR FEMA FOR ANY RIPARIAN BUFFER, WETLAND &/OR FLOODPLAIN IMPACTS (RESPECTIVELY) PRIOR TO

11. NCDOT / RAILROAD ENCROACHMENT AGREEMENTS ARE REQUIRED FOR ANY UTILITY WORK (INCLUDING MAIN EXTENSIONS & SERVICE TAPS) WITHIN STATE OR RAILROAD ROW PRIOR TO CONSTRUCTION

12. GREASE INTERCEPTOR / OIL WATER SEPARATOR SIZING CALCULATIONS & INSTALLATION SPECIFICATIONS SHALL BE APPROVED BY THE CORPUD FOG PROGRAM COORDINATOR PRIOR TO ISSUANCE OF A BUILDING PERMIT. CONTACT TIM BEASLEY AT (919) 996-2334 OR TIMOTHY.BEASLEY@RALEIGHNC.GOV FOR MORE INFORMATION

13. CROSS-CONNECTION CONTROL PROTECTION DEVICES ARE REQUIRED BASED ON DEGREE OF HEALTH HAZARD INVOLVED AS LISTED IN APPENDIX-B OF THE RULES GOVERNING PUBLIC WATER SYSTEMS IN NORTH CAROLINA. THESE GUIDELINES ARE THE MINIMUM REQUIREMENTS. THE DEVICES SHALL MEET AMERICAN SOCIETY OF SANITARY ENGINEERING (ASSE) STANDARDS OR BE ON THE UNIVERSITY OF SOUTHERN CALIFORNIA APPROVAL LIST. THE DEVICES SHALL BE INSTALLED AND TESTED (BOTH INITIAL AND PERIODIC TESTING THEREAFTER) IN

- PROPOSED UTILITIES SHALL BE PLACED A MINIMUM 5' OFF EDGE OF PAVEMENT WHERE SHOWN.

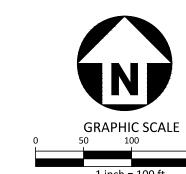

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MCADAMS

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2905 Meridian Parkway

Durham, NC 27713 phone 919. 361. 5000


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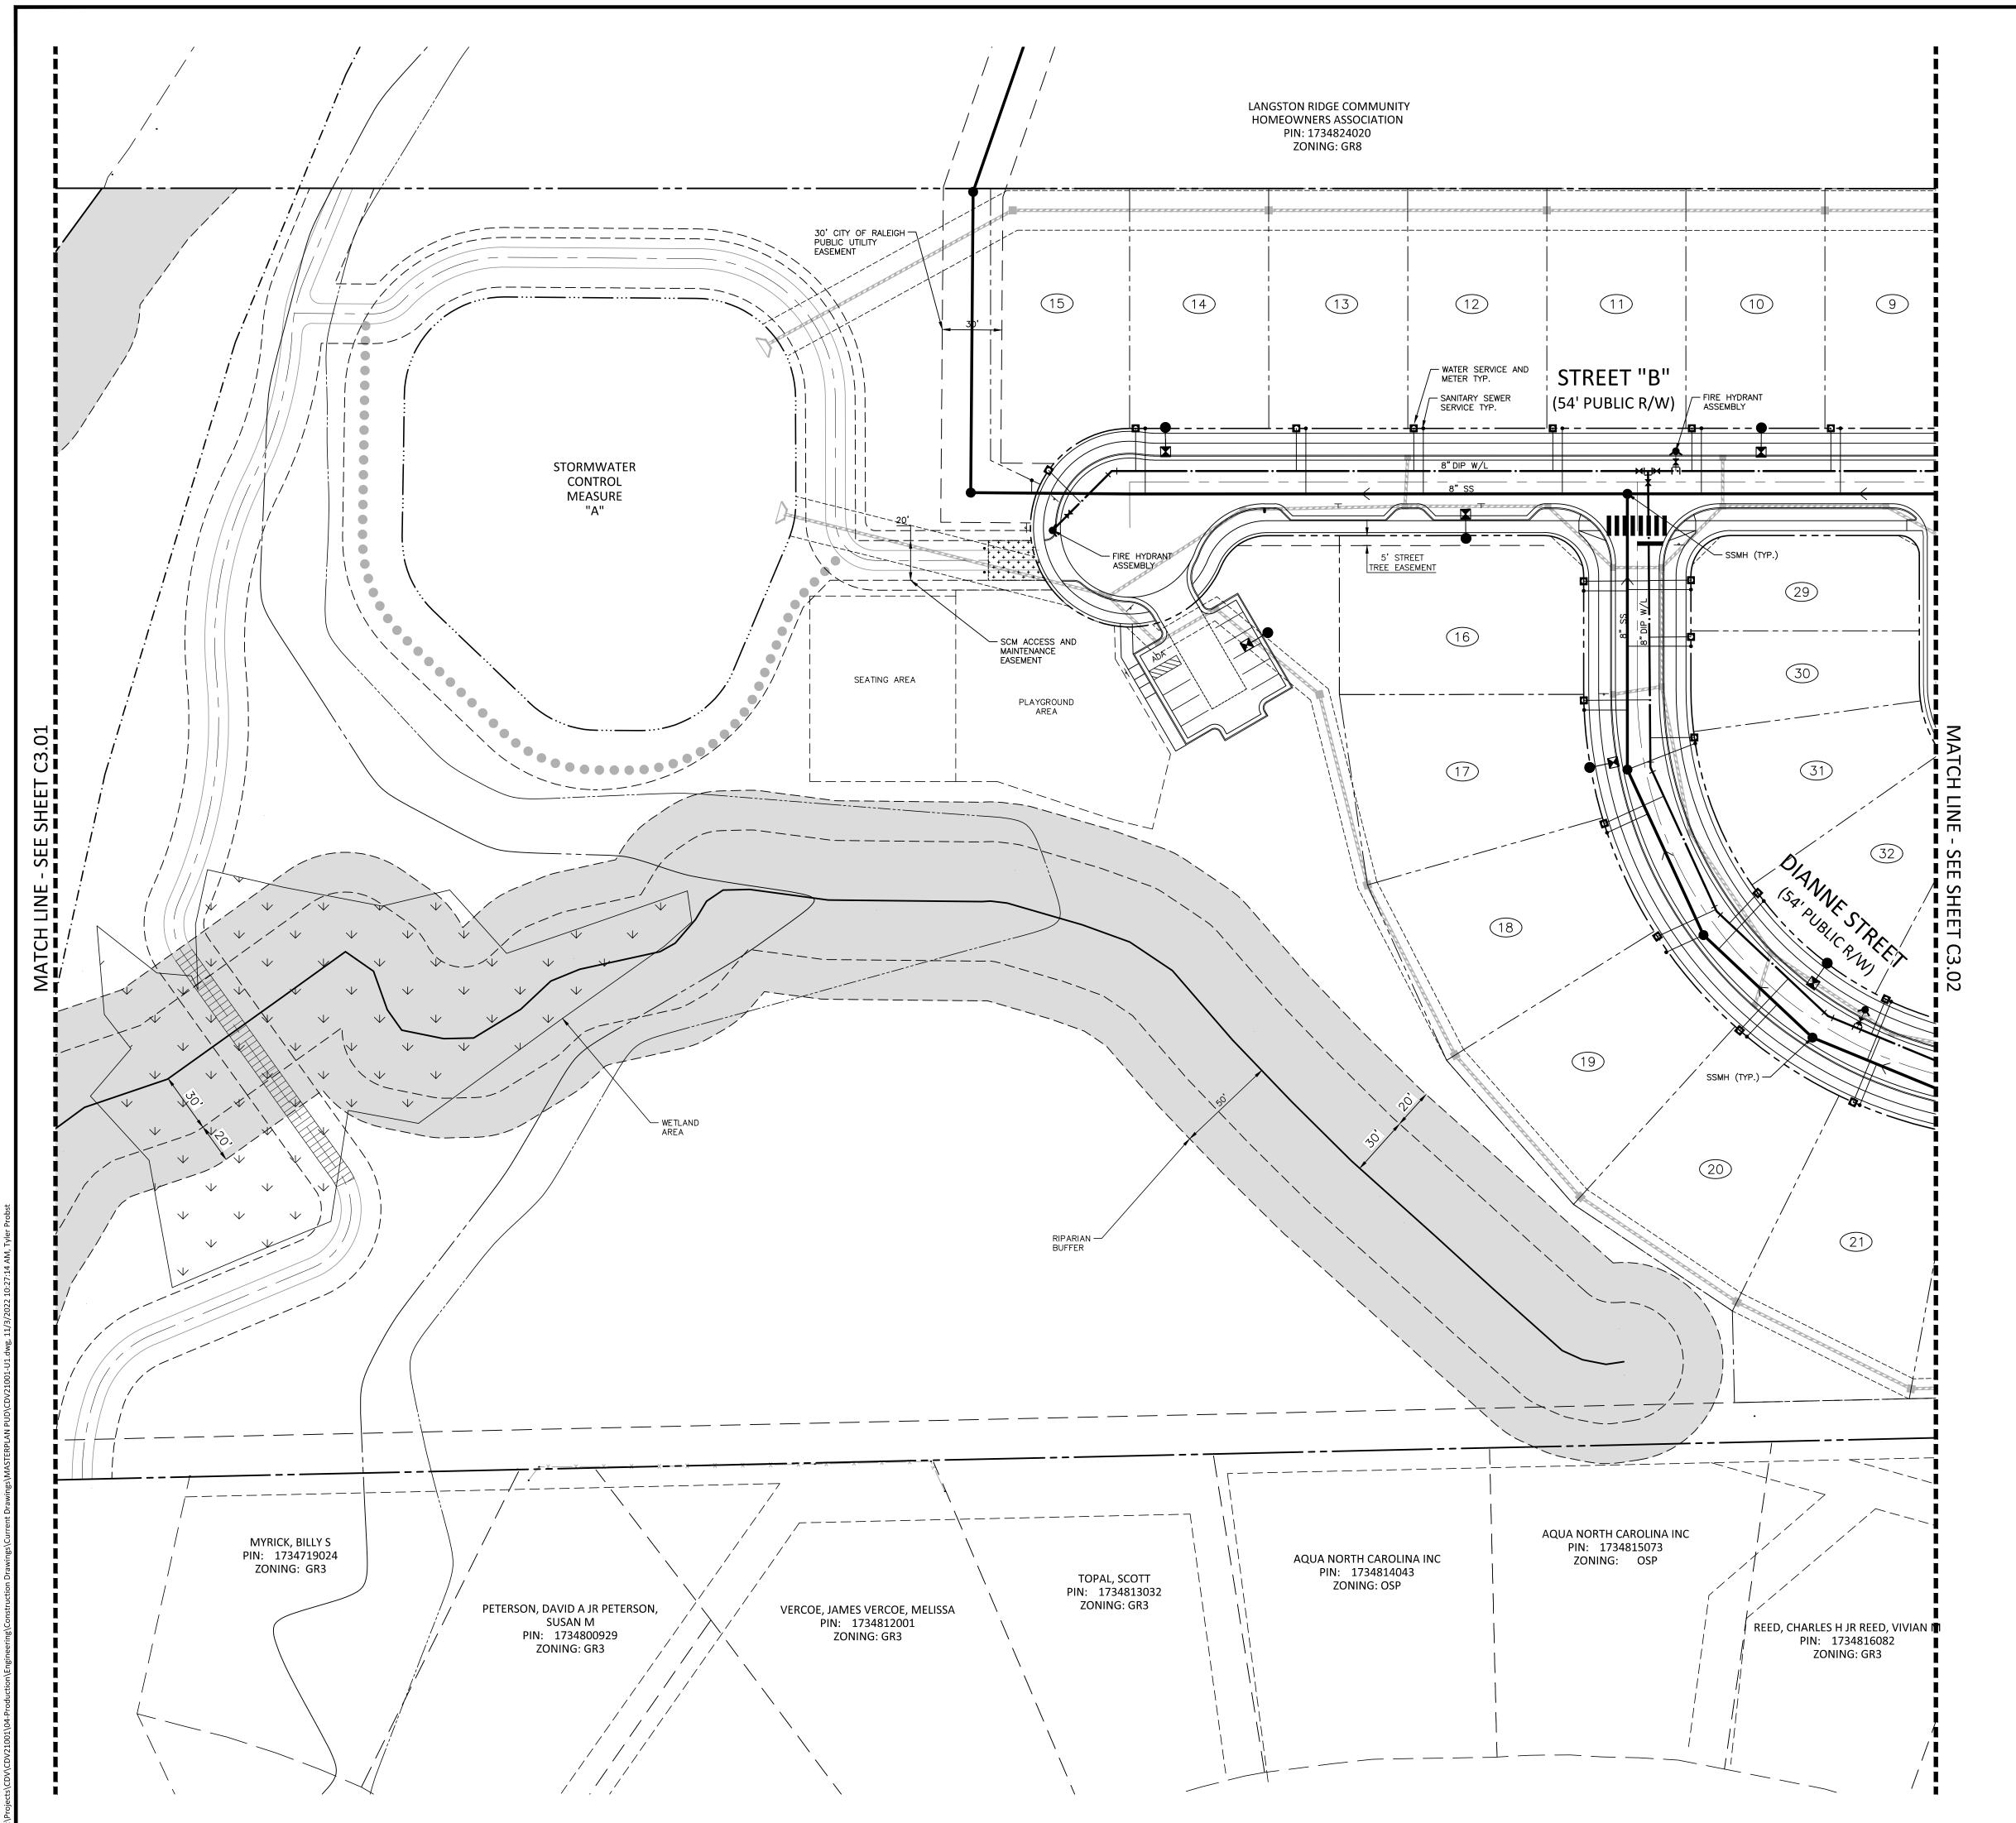
PLAN INFORMATION

PROJECT NO. CDV21001 FILENAME CDV21001-OAU1 CHECKED BY DRAWN BY 1" = 100' SCALE

DATE SHEET

OVERALL UTILITY PLAN

08. 22. 2022

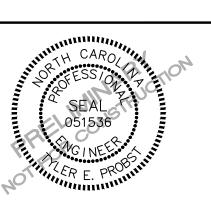

UTILITY LEGEND

FIRE HYDRANT ASSEMBLY

FIRE DEPARTMENT CONNECTION (FDC)

WATER METER

WATER VALVE

POST INDICATOR VALVE

VALVE IN MANHOLE

METER & VAULT

BACKFLOW PREVENTER

REDUCER

PLUG

BLOW-OFF ASSEMBLY

SANITARY SEWER MANHOLE

SEWER CLEAN-OUT

SEWER FLOW DIRECTION ARROW

YARD LIGHTS

LIGHT POLE

POWER POLE

LINE BREAK SYMBOL

WATERLINE

WATER SERVICE LINE

UTILITY SLEEVE

SANITARY SEWER

SEWER SERVICE LINE

SEWER SERVICE LINE

SEWER FORCE MAIN

GGGGGGGGGGGAS LINE


OU—OU—OU—OVERHEAD UTILITY

UE—UE—UE—UDERGROUND ELECTRIC

T—T—T—T—T—T—TELEPHONE

— — — EASEMENT LINE

AREA "A" AREA "B"

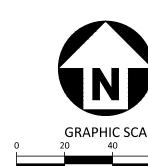

GRAPHIC SCALE

1 inch = 40 ft.

PRELIMINARY DRAWING - NOT RELEASED FOR CONSTRUCTION



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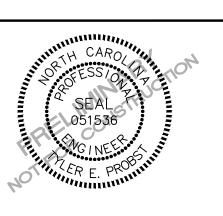
CLIENT

PHONE: 919. 931. 2300

CAROLINA DEVELOPMENT GROUP, LLC 10136 MIZNER LANE RALEIGH, NC MARK PURYEAR

RIVER POINTE
MASTER PLAN

S AND 107 COLCHESTER DRIVE
KNIGHTDALE, NC 27545



REVISIONS

NO. DATE
 1 09. 30. 2022 REV PER DRC COMMENT
 2 11. 04. 2022 REV PER PUBLIC HEARING

PLAN INFORMATION

PROJECT NO. CDV21001

FILENAME CDV21001-U1

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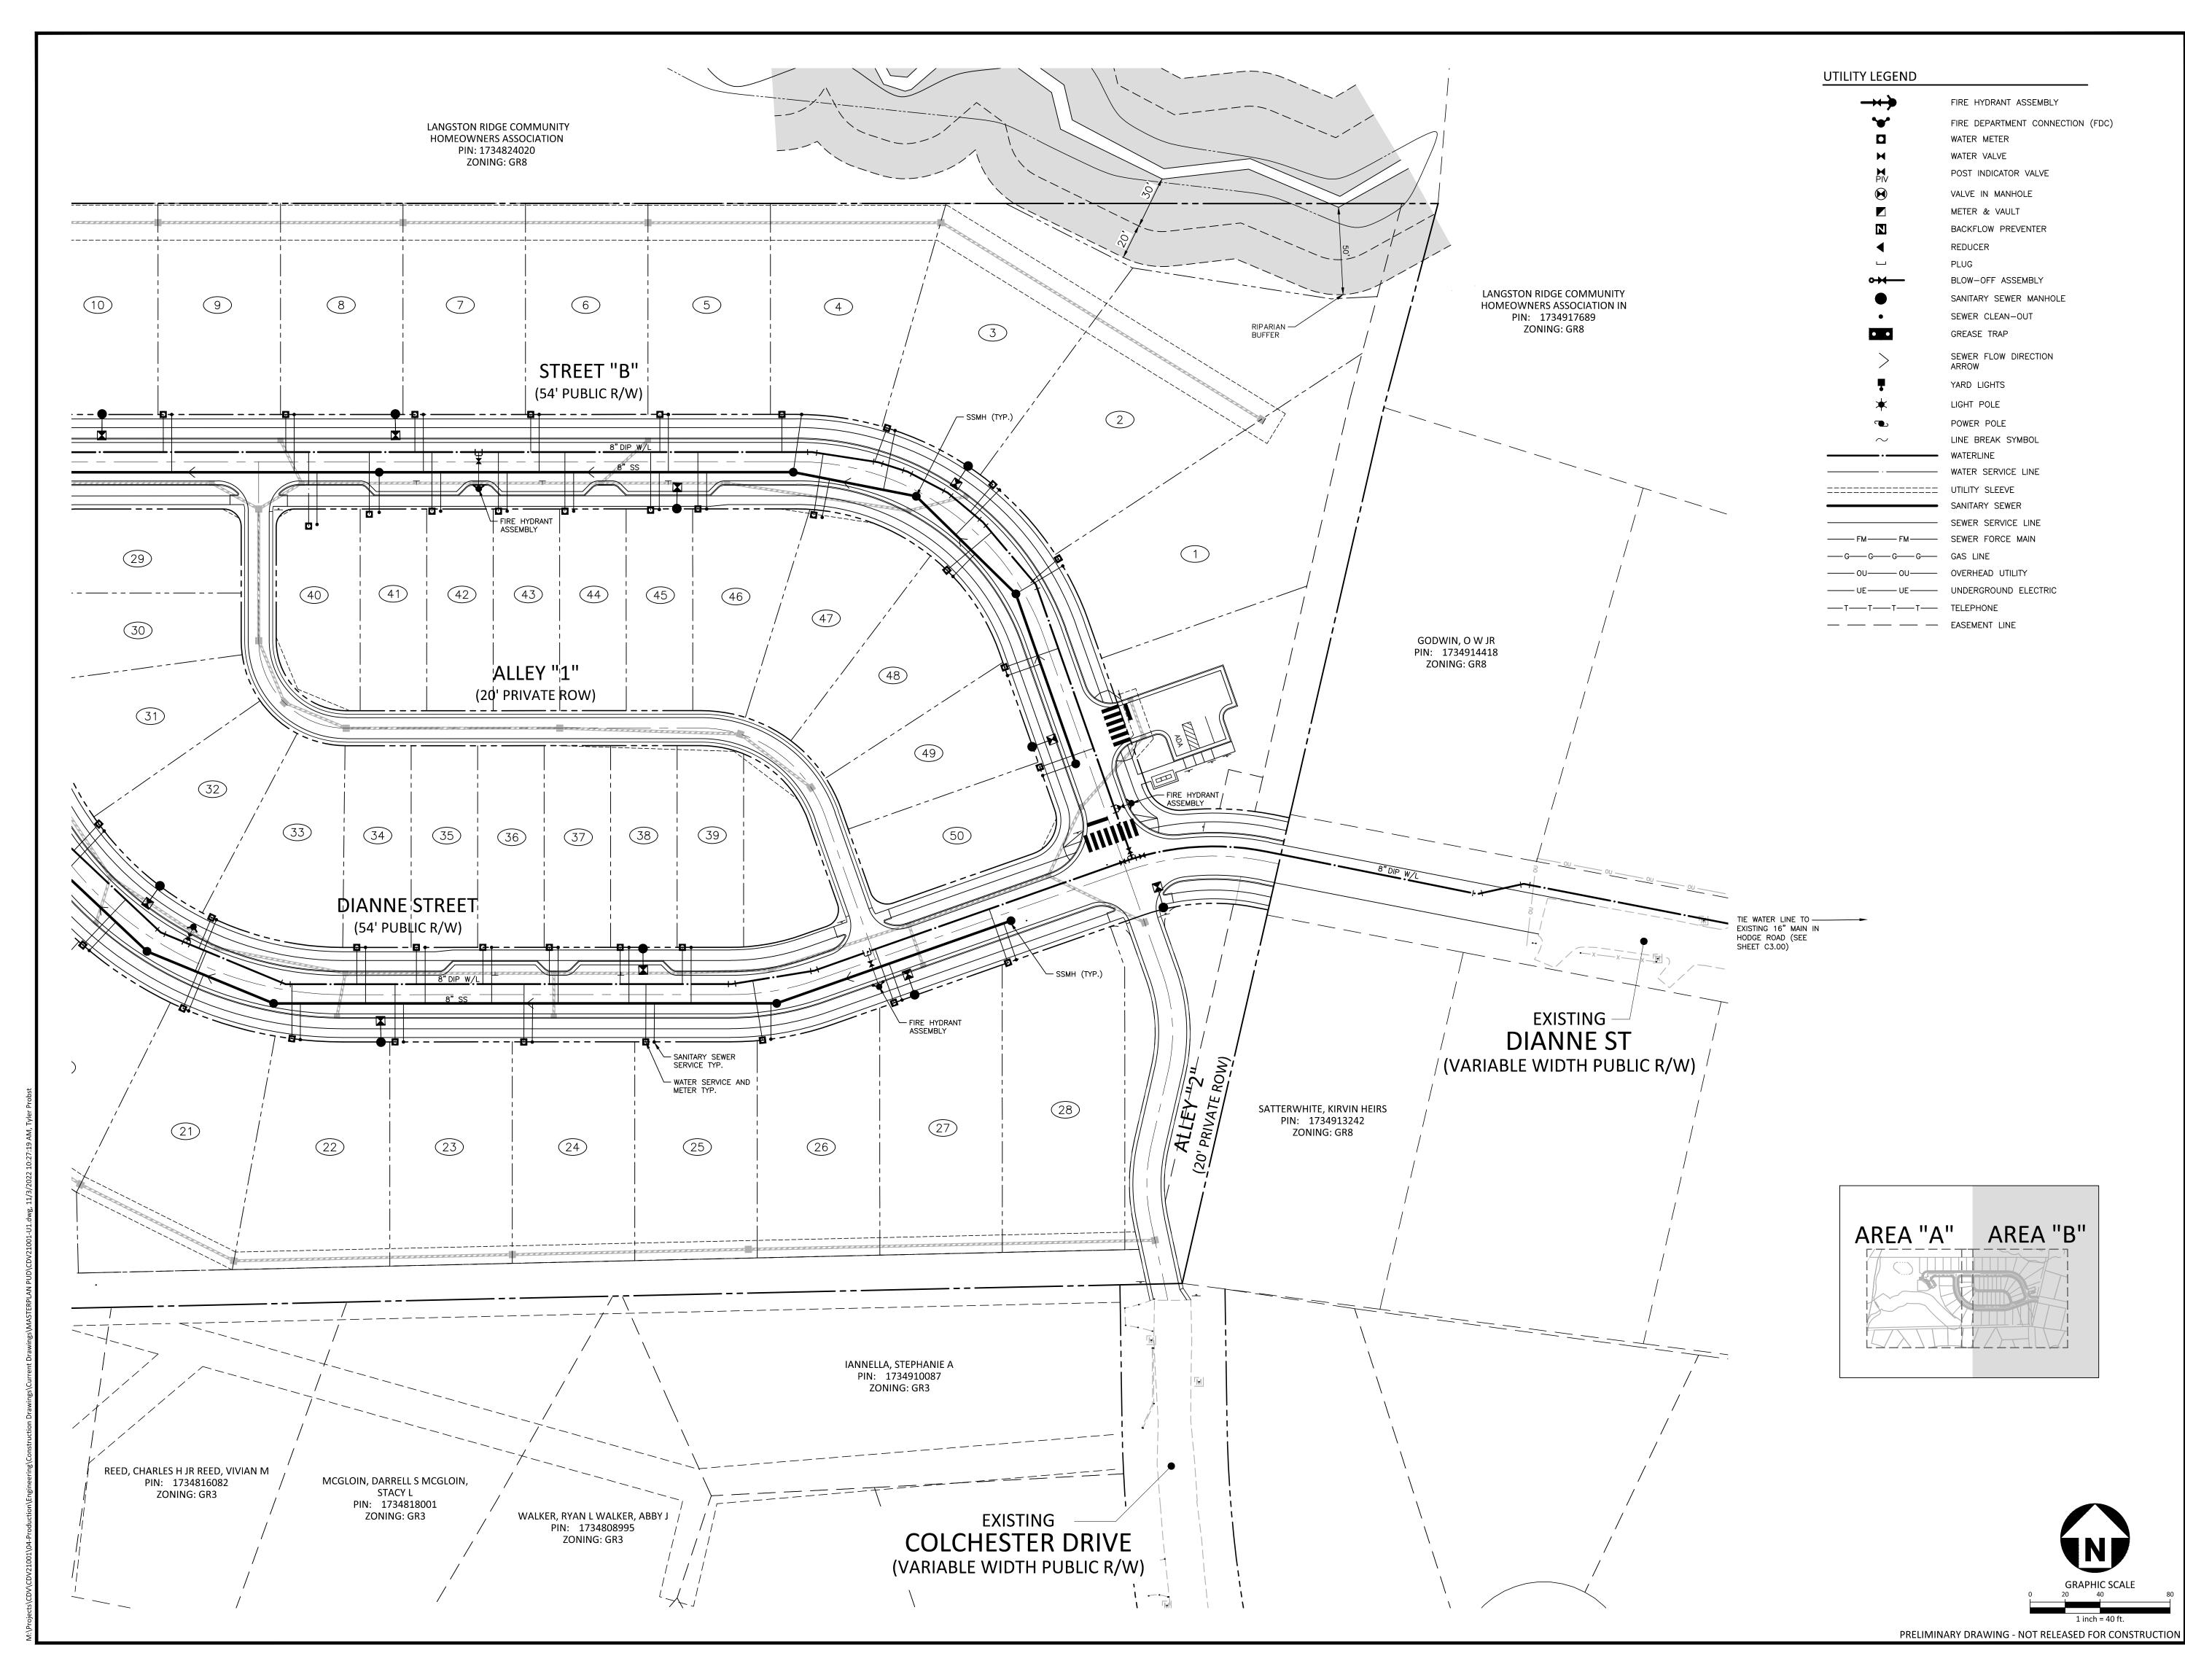
SCALE 1" = 40'

DATE 08. 22. 2022

SHEET

UTILITY PLAN AREA "A"

C3.01





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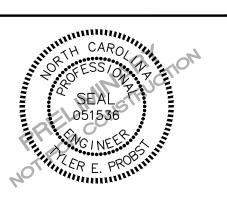
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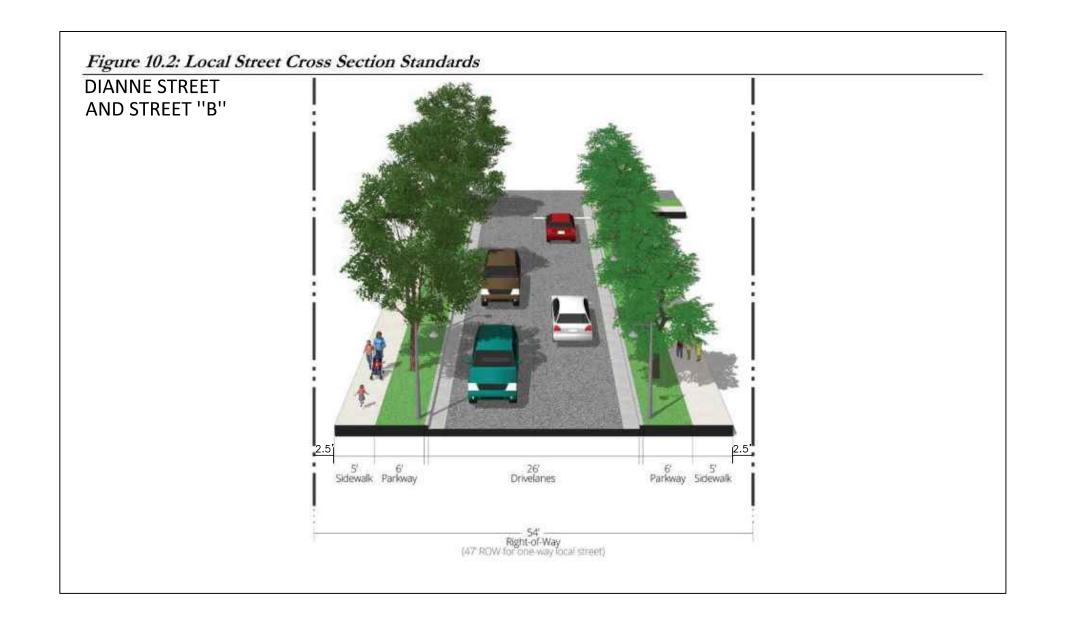
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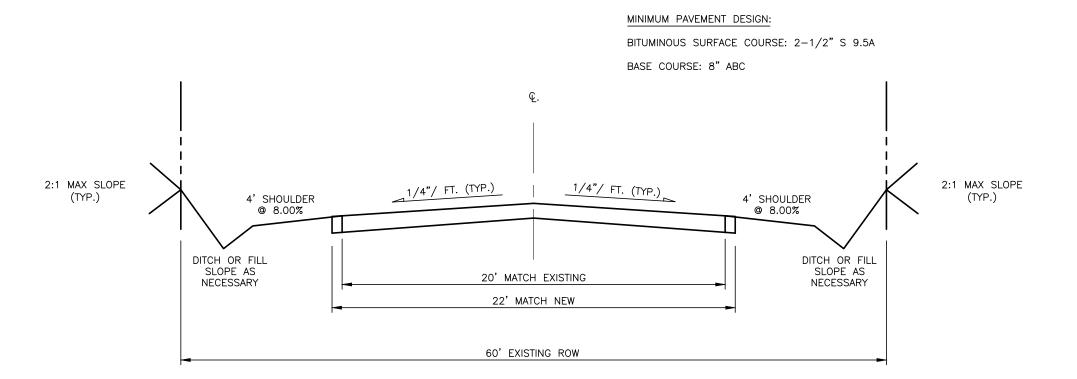
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SHEET

UTILITY PLAN AREA "B"


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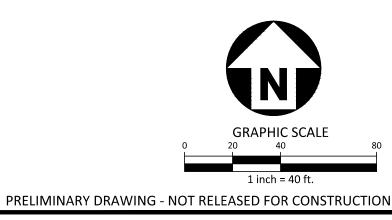
08. 22. 2022





DIANNE STREET EXTENSION



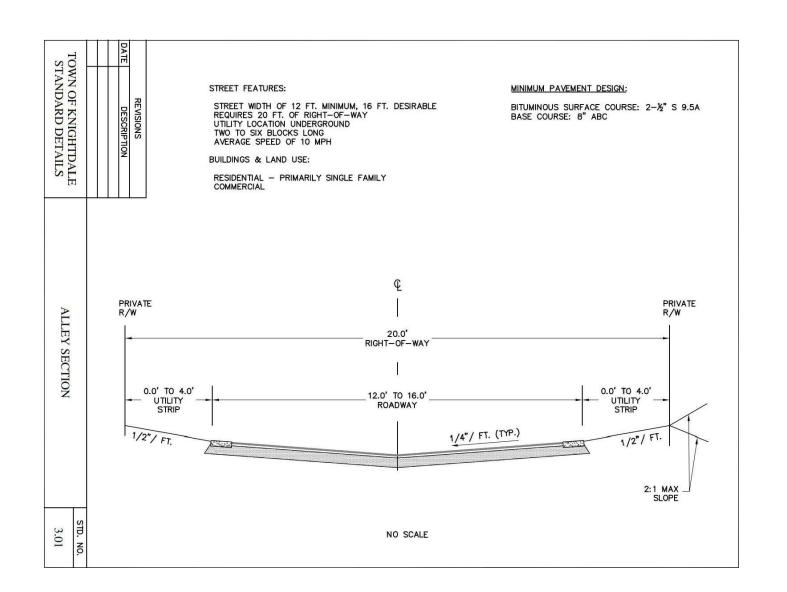



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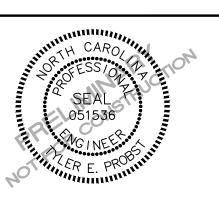
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RIVER POINTE MASTER PLAN 105 AND 107 COLCHESTER DRIVE KNIGHTDALE, NC 27545



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NO. DATE

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PLAN INFORMATION

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FILENAME CDV21001-D1

CHECKED BY JCM

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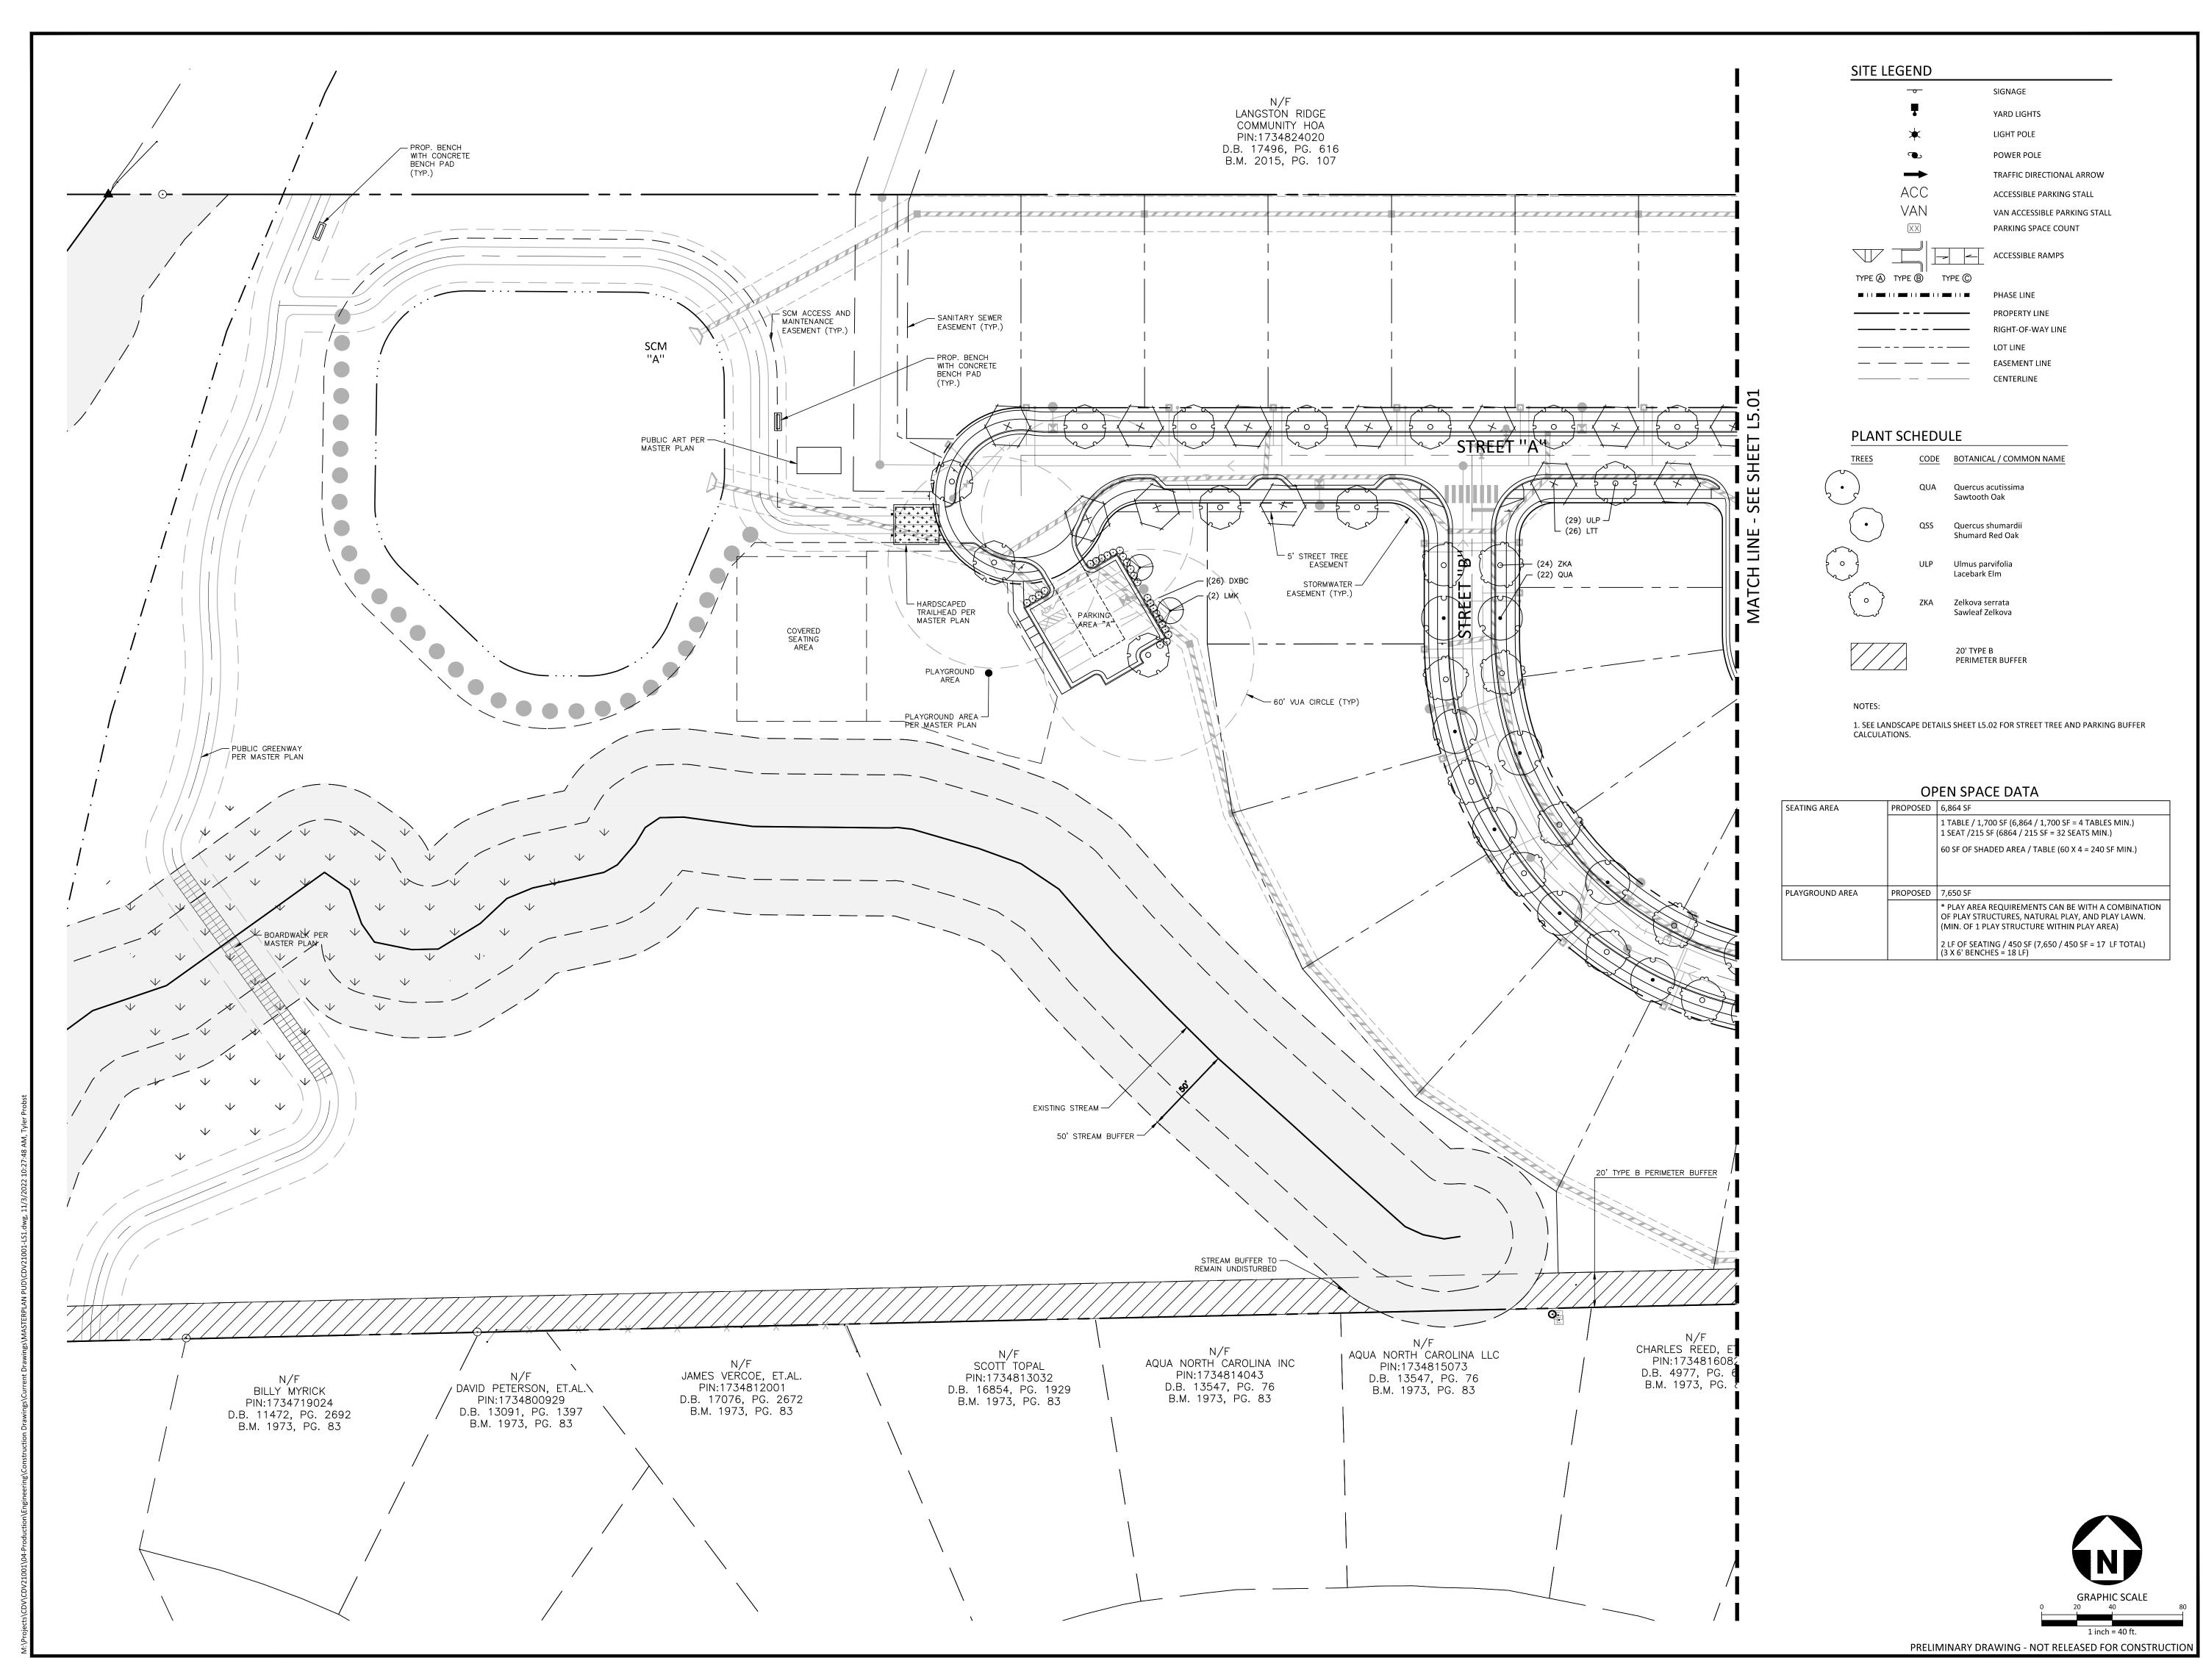
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DATE 08. 22. 2022

SHEET

TYPICAL SECTIONS

C8.00





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MASTER PLAN S AND 107 COLCHESTER DRIVIEW KNIGHTDALE, NC 27545



REVISIONS

NO. DATE

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2 11 04 2022 REV PER PUBLIC HEARING

2 11. 04. 2022 REV PER PUBLIC HEARING
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PLAN INFORMATION

PROJECT NO. CDV21001

FILENAME CDV21001-LS1

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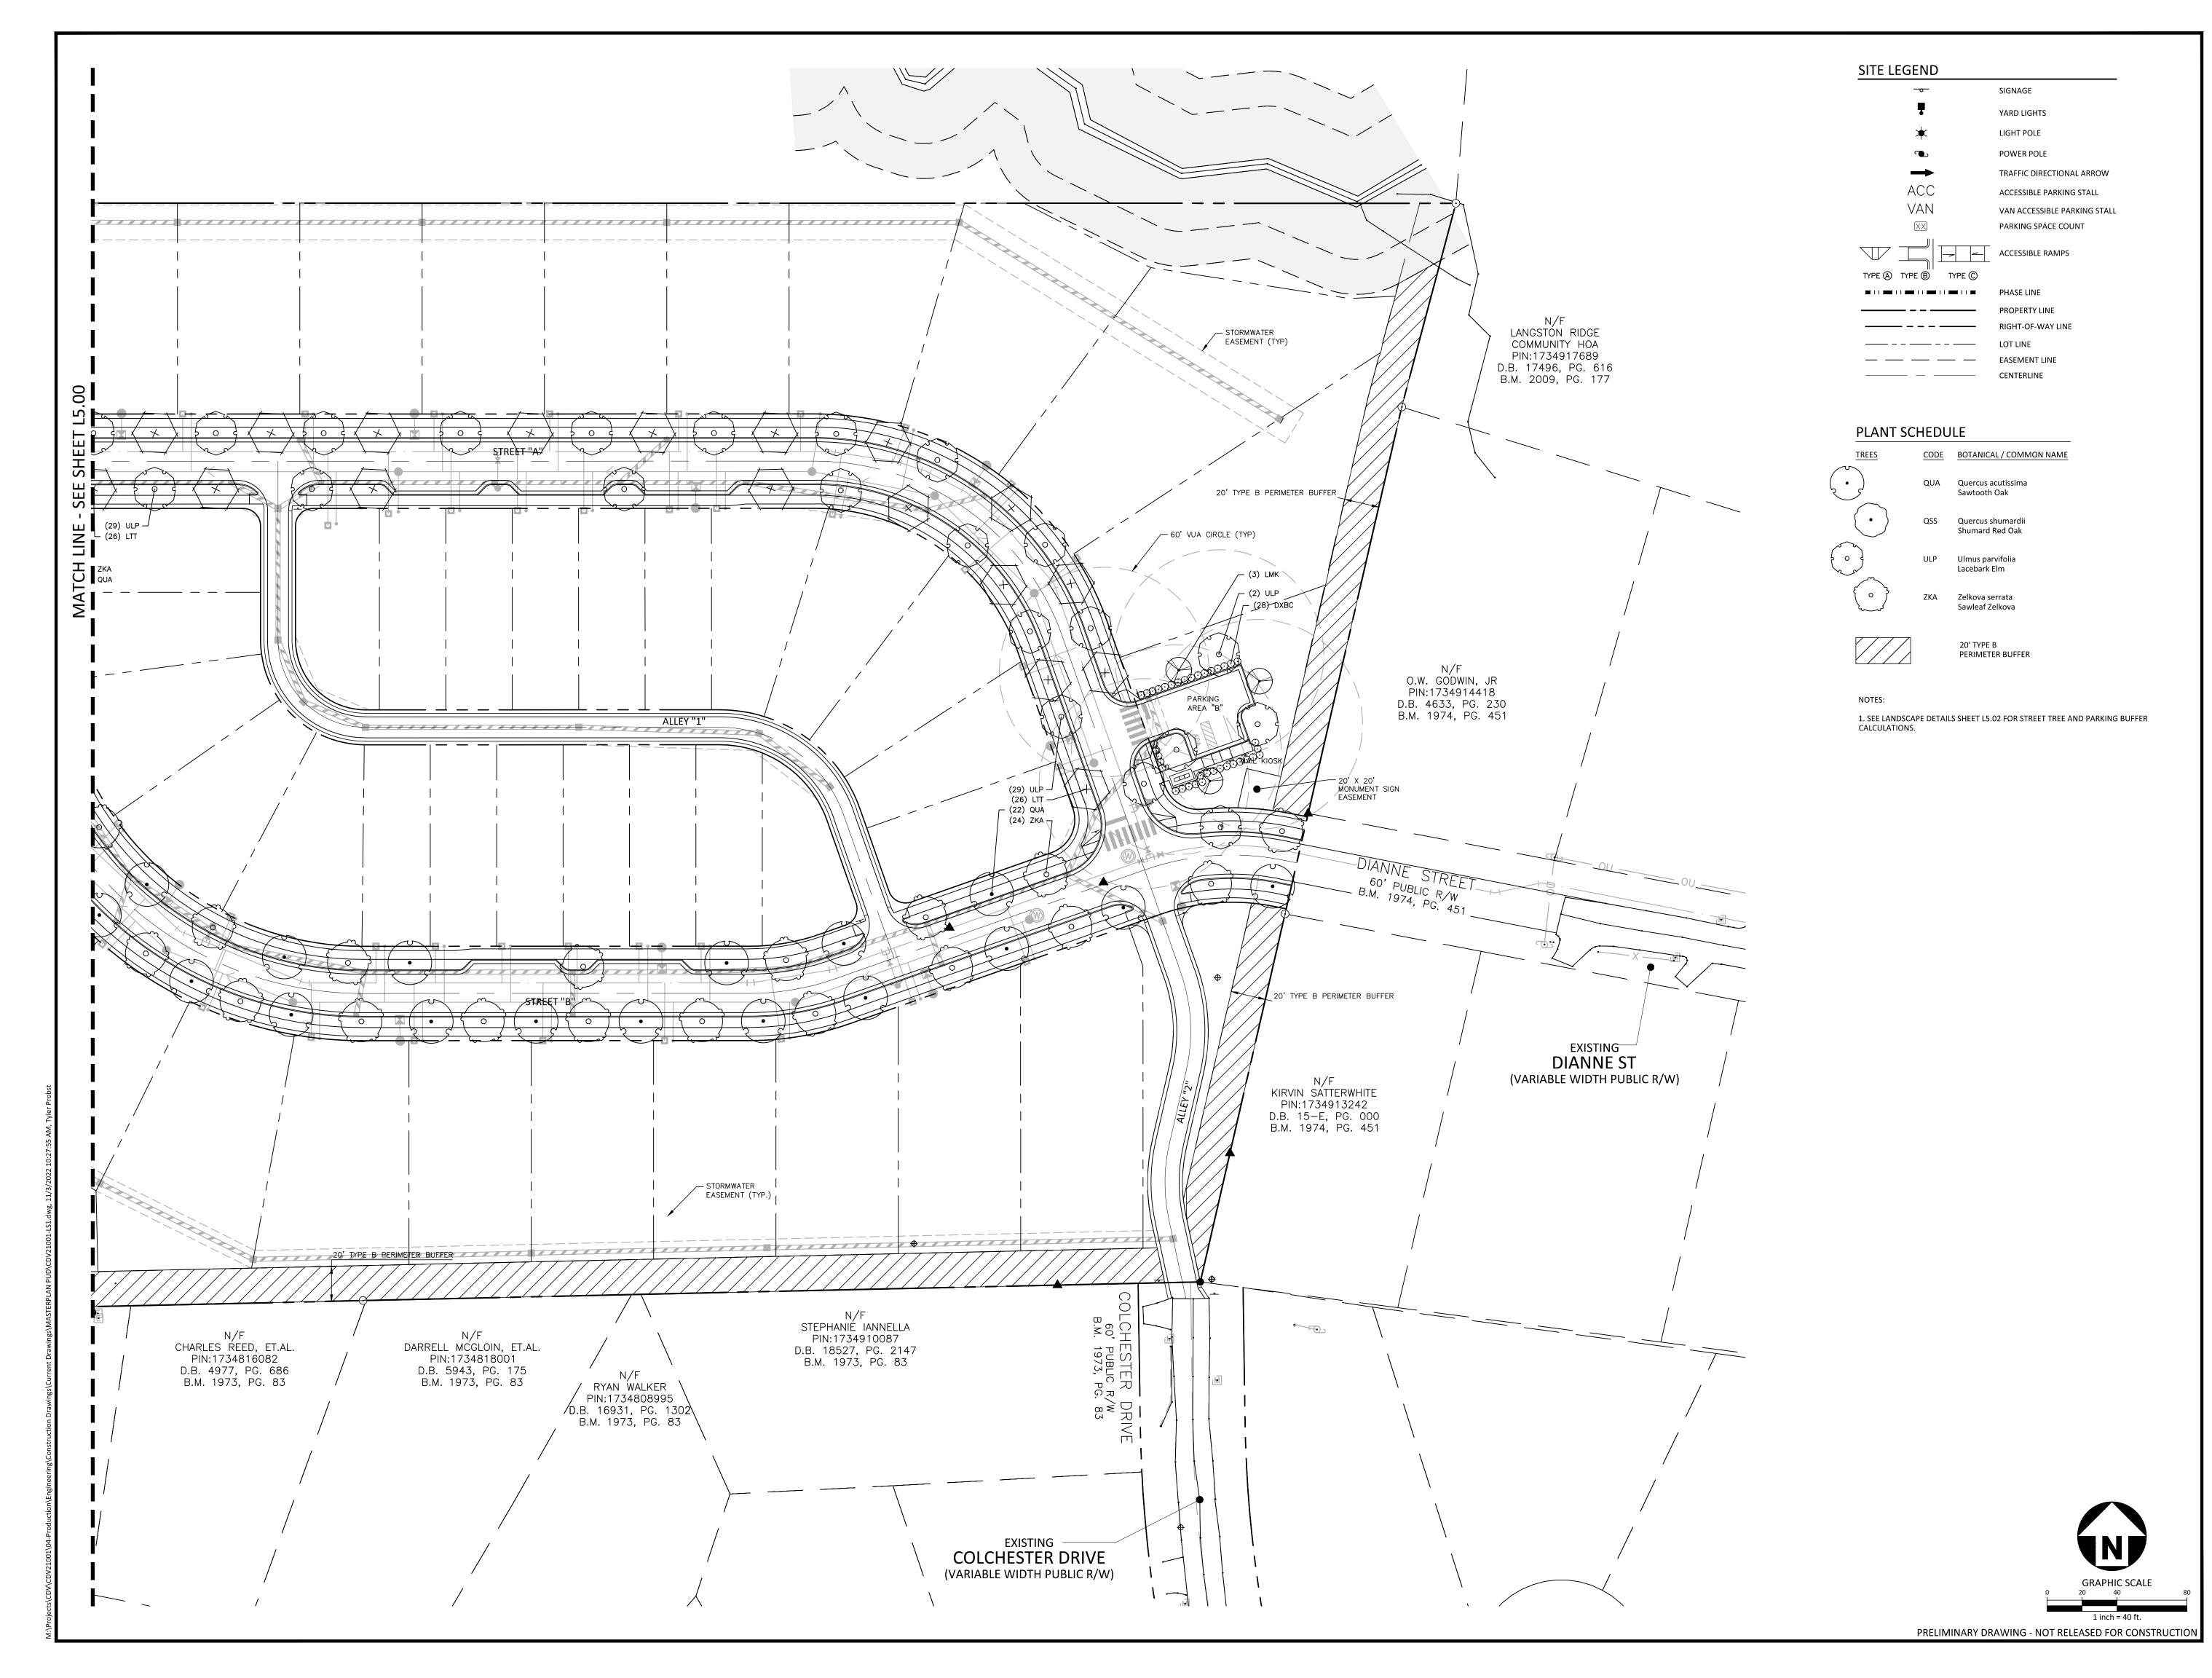
SCALE 1" = 40'

DATE 08. 22. 2022

SHEET

LANDSCAPE PLAN AREA
''A''

L5.00





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MASTER PLAN
05 AND 107 COLCHESTER DRIVE
KNIGHTDALE, NC 27545



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2 11. 04. 2022 REV PER PUBLIC HEARING
 3
 4

PLAN INFORMATION

PROJECT NO. CDV21001

FILENAME CDV21001-LS1

CHECKED BY MDS

DRAWN BY JJB

SCALE 1" = 40'

DATE 08. 22. 2022

SHEET

LANDSCAPE PLAN AREA

L5.01

GENERAL LANDSCAPE NOTES:

- 1. ALL MATERIALS AND METHODS OF CONSTRUCTION SHALL BE IN ACCORDANCE WITH THE TOWN OF KNIGHTDALE AND THE STATE OF NORTH CAROLINA STANDARDS AND SPECIFICATIONS.
- 2. CONTRACTOR IS RESPONSIBLE FOR THE SITE INSPECTION BEFORE LANDSCAPE CONSTRUCTION AND INSTALLATION IN ORDER TO BECOME FAMILIAR WITH THE EXISTING CONDITIONS.
- 3. LANDSCAPE CONTRACTOR IS RESPONSIBLE FOR LOCATING ALL UNDERGROUND UTILITIES BEFORE BEGINNING DEMOLITION OR INSTALLATION.
- 4. CONTRACTOR SHALL NOTIFY LANDSCAPE ARCHITECT OF ANY DISCREPANCIES BETWEEN THE NOTES, SPECIFICATIONS, DRAWINGS OR SITE CONDITIONS FOR RESOLUTION PRIOR TO INSTALLATION.
- 5. ANY DAMAGE TO UTILITIES SHALL BE REPAIRED AT THE CONTRACTOR'S EXPENSE.
- 6. VERIFICATION OF TOTAL PLANT QUANTITIES AS SHOWN IN THE PLANT SCHEDULE SHALL BE THE RESPONSIBILITY OF THE LANDSCAPE CONTRACTOR. ANY DISCRPANCIES SHALL BE BROUGHT TO THE ATTENTION OF THE LANDSCAPE ARCHITECT.
- 13. SUBSTITUTIONS OF SPECIFIC PLANTS CAN ONLY OCCUR WITH PRIOR WRITTEN PERMISSION OF BOTH OWNER AND LANDSCAPE ARCHITECT.
- 14. CONTRACTOR TO ENSURE PROPER STABILIZATION AND SEEDING OF THE SITE IN ACCORDANCE WITH APPLICABLE REGULATIONS.
- 15. LANDSCAPE MATERIAL SHALL BE WELL FORMED, VIGOROUS, GROWING SPECIMENS WITH GROWTH TYPICAL OF VARIETIES SPECIFIED AND SHALL BE FREE FROM DAMAGE, INSECTS AND DISEASES. MATERIAL SHALL EQUAL OR SURPASS #1 QUALITY AS DEFINED IN THE CURRENT ISSUE OF "AMERICAN STANDARD FOR NURSERY STOCK" AS PUBLISHED BY AMERICAN HORT -AMERICANHORT.ORG.
- 16. ALL PLANT MATERIAL IS TO BE CAREFULLY HANDLED BY THE ROOT BALL, NOT THE TRUNK, BRANCHES AND/OR FOLIAGE OF THE PLANT. MISHANDLED PLANT MATERIAL MAY BE REJECTED BY THE LANDSCAPE ARCHITECT.
- 17. ALL PLANT MATERIAL IS TO BE WELL ROOTED, NOT ROOT BOUND, SUCH THAT THE ROOT BALL REMAINS INTACT THROUGHOUT THE PLANTING PROCESS. DEFICIENT PLANT MATERIAL MAY BE REJECTED BY THE LANDSCAPE ARCHITECT OR OWNER.
- 18. ALL PLANTS TO BE A MINIMUM OF WHAT IS SPECIFIED IN THE PLANT SCHEDULE. ANY CHANGES OR SUBSTITUTIONS SHALL BE APPROVED BY THE LANDSCAPE ARCHITECT AND GOVERNING JURISDICTION PRIOR TO ANY HOLE BEING DUG.
- 19. ALL TREES MUST BE PLANTED AFTER OCTOBER 1 AND BEFORE MARCH 31.

FROM TRUNK OF THE TREE TO THE HYDRANT.

- 20. CONTRACTOR TO COORDINATE WITH OWNER'S REPRESENTATIVE AND LANDSCAPE ARCHITECT TO ESTABLISH THE EXTENTS OF MULCH/SEED/SOD IF NOT SPECIFICALLY SHOWN ON PLANS.
- 21. CONTRACTOR SHALL PROVIDE POSITIVE DRAINAGE IN ALL PLANTING AREAS.
- 22. PROPOSED TREES TO BE PLANTED A MINIMUM 10 FEET FROM ANY LIGHT POLE AS MEASURED FROM TRUNK OF THE TREE TO THE POLE.
- 24. ALL TREE PLANTINGS SHALL BE MULCHED WITH 3 INCHES OF SHREDDED BARK OR 4 INCHES OF PINE STRAW IN A 3 FOOT RADIUS AROUND THE TREE, OR TO THE DRIPLINE, WHICHEVER IS GREATER. THE MULCH SHALL BE FREE OF TRASH AND MAINTAINED WEED FREE THEREAFTER. MULCH SHALL NOT COVER THE ROOT COLLAR.

23. PROPOSED TREES TO BE PLANTED A MINIMUM 5 FEET FROM ANY FIRE HYDRANT AS MEASURED

MAINTENANCE NOTES:

- 1. WARRANTY: INSTALLER SHALL REPAIR OR REPLACE ANY PLANTINGS THAT FAIL IN MATERIALS, WORKMANSHIP, OR GROWTH WITHIN ONE YEAR AFTER THE DATE OF SUBSTANTIAL COMPLETION. FAILURES INCLUDE, BUT ARE NOT LIMITED TO, THE FOLLOWING:
- DEATH AND UNSATISFACTORY GROWTH, EXCEPT FOR DEFECTS RESULTING FROM LACK OF ADEQUATE MAINTENANCE, NEGLECT, ABUSE BY OWNER, OR INCIDENTS THAT ARE BEYOND CONTRACTOR'S CONTROL.
- STRUCTURAL FAILURES INCLUDING PLANTINGS FALLING OR BLOWING OVER.
- 2. THE OWNERS OF PROPERTY SHALL BE RESPONSIBLE FOR ALL NATURAL AND PHYSICAL FEATURES REQUIRED BY CODE AND SHALL PRESERVE AND MAINTAIN THESE FEATURES IN HEALTHY GROWING CONDITIONS, REPLACE THEM WHEN NECESSARY, AND KEEP THE AREAS AROUND THEM FREE OF REFUSE AND DEBRIS IN A MANNER THAT PREVENTS REFUSE AND DEBRIS FROM WASHING ONTO PUBLIC
- RIGHTS-OF-WAY. FAILURE TO MAINTAIN ALL PLANTINGS IN ACCORDANCE WITH THIS PLAN MAY CONSTITUTE A VIOLATION OF THIS ORDINANCE AND MAY RESULT IN FINES. THE OWNER SHALL BE RESPONSIBLE FOR MAINTENANCE OF THE VEGETATION, INCLUDING BUT NOT LIMITED TO:
- FERTILIZATION PRUNING WITHIN LIMITS
- PEST CONTROL
- MULCHING
- MOWING PROTECTION OF THE ROOT ZONES FROM EQUIPMENT, CONSTRUCTION AND RELATED MATERIALS, ETC.
- METHOD OF IRRIGATION

RESIDENTIAL LANDSCAPING NOTES:

OTHER CONTINUING MAINTENANCE OPERATIONS

- 1. EACH SINGLE-FAMILY OR DUPLEX LOT SHALL CONTAIN A MINIMUM OF ONE CANOPY TREE FOR EVERY 2,000 SF OF LOT AREA OR FRACTION THEREOF UP TO 20,000 SF IN LOT AREA. ANY PORTION OF THE RESIDENTIAL LOT OCCUPIED BY A RECORDED UTILITY EASEMENT SHALL NOT BE INCLUDED AS PART OF THE TOTAL LOT AREA. THE LOCATION OF PLANTING TO ACCOUNT FOR PHYSICAL CONDITIONS MAY BE ADJUSTED BY THE ADMINISTRATOR.
- THE USE OF EXISTING TREES MEETING THE FOLLOWING STANDARDS TO SATISFY THIS REQUIREMENT IS ENCOURAGED. EXISTING LARGE SHADE TREES MEASURING MORE THAN 6 INCHES IN DBH MAY BE COUNTED TOWARDS FULFILLING THIS REQUIREMENT.
- 3. REQUIRED STREET TREES MAY NOT BE COUNTED TOWARDS THE FULFILLMENT OF THE RESIDENTIAL LANDSCAPING REQUIREMENT. APART FROM REQUIRED STREET TREES, ALL OTHER TREES REQUIRED FOR RESIDENTIAL LANDSCAPING SHALL BE PLANTED WITHIN THE PRIVATE LOT.
- 4. FOUNDATION PLANTINGS CONSISTING OF EVERGREEN SHRUBS SHALL BE INSTALLED ALONG THE ENTIRE FOUNDATION WALL OF THE BUILDING. PLANT INSTALLATION SHALL BE A MINIMUM OF TWO FEET IN HEIGHT PLANTED AT FOUR FOOT INTERVALS.

LANDSCAPE CALCULATIONS

PERIMETER BUFFERS

SOUTHERN PROPERTY	/ LINE	1,783 LF*	STREET "A"	
20' TYPE B BUFFER			-	
CANOPY TREES REQUIRED: PROVIDED:	53 (3/100 LF) 53**		CANOPY TREES REQUIRED: PROVIDED:	47 (1/40 LF) 47
LINDEDCTORY TREE	-6		STREET "B"	
UNDERSTORY TREE			-	
REQUIRED:	89 (5/100 LF)		CANOPY TREES	
PROVIDED:	89**		REQUIRED:	52 (1/40 LF)
			PROVIDED:	52
SHRUBS			TROVIDED.	32
REQUIRED:	356 (20/100 LF)			
PROVIDED:	356* [*] *			

EASTERN PROPERTY LINE E001E*

10 SPACES	PARKING AREA "A"	580 LF*	<u> </u>	EASTERN PROPERTY LIN
				20' TYPE B BUFFER
ALL CRACES MUTUAL COLOR CANODY TREE	CANOPY TREES		ING , 54LF STREET ROW	634TOTAL LF SUBTRACT
ALL SPACES WITHIN 60' OF CANOPY TREE	REQUIRED:			CANOPY TREES
1	PROVIDED:		17 (3/100 LF)	REQUIRED:
3 SPACES	PARKING AREA "B"		17**	PROVIDED:
	CANOPY TREES			UNDERSTORY TREES
ALL SPACES WITHIN 60' OF CANOPY TREE	REQUIRED:		29 (5/100 LF)	REQUIRED:
1	PROVIDED:		29**	PROVIDED:

SHRUBS REQUIRED: 116 (20/100 LF) PROVIDED:

*BUFFER PLANTS TO BE INSTALLED PER STANDARD BUFFER DETAILS THIS SHEET. FINAL LOCATIONS OF PLANTINGS TO BE COORDINATED WHEN ENHANCED LANDSCAPE PLANS ARE DEVELOPED. *EXISTING PLANT MATERIAL TO BE PRESERVED IN ALL BUFFER AREAS AS PRIORITY

TIER 1 TREE SAVE AREAS. WHERE SUFFICIENT MATERIAL DOES NOT MEET REQUIREMENTS, SUPPLEMENTAL PLANT MATERIAL WILL BE REQUIRED FOR BUFFER TO MEET TYPE B BUFFER OPACITY STANDARDS.

LANDSCAPE CALCULATIONS

STREET TREES			TREES	CODE	QTY	BOTANICAL / COMMON NAME	CAL	HEIGHT	CONT	REMARKS
STREET "A"		1908 LF		LMK	5	Lagerstroemia indica x fauriei 'Muskogee' Muskogee Crape Myrtle	1.5" min.	10` Min.		
CANOPY TREES REQUIRED: PROVIDED:	47 (1/40 LF) 47	240415		QUA	22	Quercus acutissima Sawtooth Oak	2" min	8` min		
STREET "B"		2104 LF								
CANOPY TREES REQUIRED:	52 (1/40 LF)		CANOPY TREES	CODE	<u>QTY</u>	BOTANICAL / COMMON NAME	CAL	<u>HEIGHT</u>	CONT	REMARKS
PROVIDED:	52 (1/40 LF) 52		+	LTT	26	Liriodendron tulipifera Tulip Tree	2" min	8` min		
PARKING LOT LA	ANDSCAPING		(V							
PARKING AREA "A"		10 SPACES	bood -	ULP	31	Ulmus parvifolia Lacebark Elm	2" min	8` min		
CANODY TREES			/ '\							

ZKA

DXBC 46

Zelkova serrata

Sawleaf Zelkova

BOTANICAL / COMMON NAME

Distylium x 'PIIDIST-II'

Blue Cascade® Distylium

PLANT SCHEDULE

PARKING LOT BLIFFER

PARKING LOT BUFFER			
PARKING AREA "A"	93 L		
CANOPY TREES REQUIRED: PROVIDED:	(3 PER 100 LF OF FRONTAGE) 3 3		
UNDERSTORY TREES REQUIRED: PROVIDED:	(2 PER 100 LF OF FRONTAGE) 2 2		
UNDERSTORY TREES REQUIRED: PROVIDED:	(20 PER 100 LF OF FRONTAGE) 20 25		
PARKING AREA "B"	146 LF		
CANOPY TREES REQUIRED: PROVIDED:	(3 PER 100 LF OF FRONTAGE) 5 5		
UNDERSTORY TREES REQUIRED: PROVIDED:	(2 PER 100 LF OF FRONTAGE) 3 3		
LINIDEDCTORY TREEC	(20 DED 100 LE OF EDONITACE)		

PROVIDED:

PROVIDED:

TYPE 'B' BUFFER DETAIL

100' (Pattern A Organized)

PLANTING PERFORMANCE STANDARDS:

TARRING LOT BOT	TEN	
PARKING AREA "A"		93 LF
CANOPY TREES REQUIRED: PROVIDED:	(3 PER 100 LF OF FRONTAGE) 3 3	
UNDERSTORY TREES REQUIRED: PROVIDED:	(2 PER 100 LF OF FRONTAGE) 2 2	
UNDERSTORY TREES REQUIRED: PROVIDED:	(20 PER 100 LF OF FRONTAGE) 20 25	
PARKING AREA "B"	146 LI	<u> </u>
CANOPY TREES REQUIRED: PROVIDED:	(3 PER 100 LF OF FRONTAGE) 5 5	
UNDERSTORY TREES REQUIRED: PROVIDED:	(2 PER 100 LF OF FRONTAGE) 3 3	
UNDERSTORY TREES REQUIRED:	(20 PER 100 LF OF FRONTAGE) 30	

- UNDERSTORY TREE (5/100 LF)

100' (Pattern B Random)

- CANOPY TREE (3/100 LF)

- EVERGREEN SHRUBS

TYPE 'B' BUFFER - OPTION 1

NOT TO SCALE


CREATE A SEMI-OPAQUE BUFFER FROM THE GROUND TO A HEIGHT OF 6' AND

INTERMITTENT VISUAL OBSTRUCTION FROM A HEIGHT OF 6' UP TO A HEIGHT OF 30'. SHALL

CONTAIN HORIZONTAL OPENINGS NO GREATER THAN 20' IN WIDTH FOR INTERMITTANT VISUAL OBSTRUCTION AND NO GREATER THAN 5' IN WIDTH FOR SEMI-OPAQUE SCREEN UPON THE

AT LEAST 40% BUT NO MORE THAN 60% EACH OF CANOPY TREES AND UNDERSTORY TREES AND AT LEAST 80% OF SHRUBS PLANTED IN A BUFFER MUST BE EVERGREEN

(20 SHRUBS/100 LF)

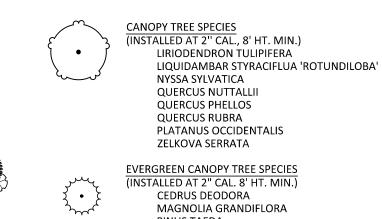

CHIONANTHUS RETUSUS CORNUS 'SPP' ILEX OPACA 'CAROLINA #2' **ILEX VOMITORIA**

EVERGREEN SHRUB SPECIES (INSTALLED AT 36" HT. MIN.) CALLICARPA AMERICANA ILEX CORNUTA 'NEEDLEPOINT' ILEX 🗘 GLABRA 'NIGRA' ILEX CRENATA 'COMPACTA' AZALEA HYBRIDS ILLICIUM PARVIFOLIUM MYRICA SP. ILEX VOMITORIA 'NANA'

2" min 8` min

18" min


SPACING CONT REMARKS

CAMELLIA SASANQUA OSMANTHUS X FORTUNEI PRUNUS CAROLINIANA HYDRANGEA MACROPHYLLA


AND QUANTITIES NOT SHOWN ON PLANT

(INSTALLED AT 1.25" CAL, 6' HT. MIN.) CARPINUS CAROLINIANA CERCIS CANADENSIS

CUT & REMOVE BURLAP FROM 1/3 OF ROOT BALL 3" (8 CM) BARK MULCH; DO NOT -PLACE MULCH WITHIN 3" OF

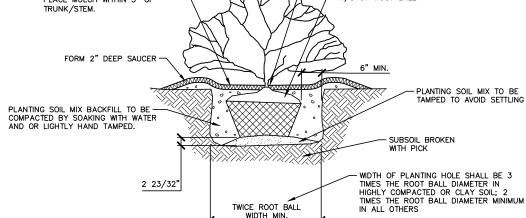

O1 SHRUB INSTALLATION SCALE: 3/8"=1'-0"

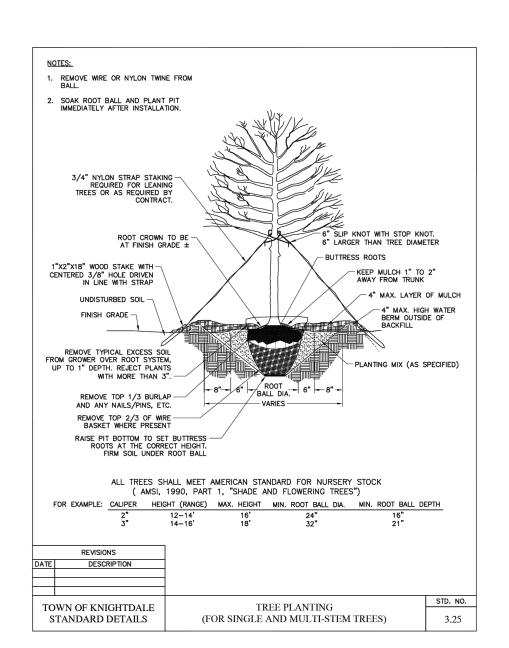

STREETSCAPE AND INTERNAL BUFFER PLANT SPECIES

PINUS TAEDA

UNDERSTORY TREE SPECIES

NOTE: PLANTS SPECIES TO BE SELECTED AT CONSTRUCTION DRAWING PHASE. SPECIES SCHEDULE.



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CAROLINA DEVELOPMENT GROUP, LLC

CLIENT

RALEIGH, NC

MARK PURYEAR

10136 MIZNER LANE

PHONE: 919. 931. 2300

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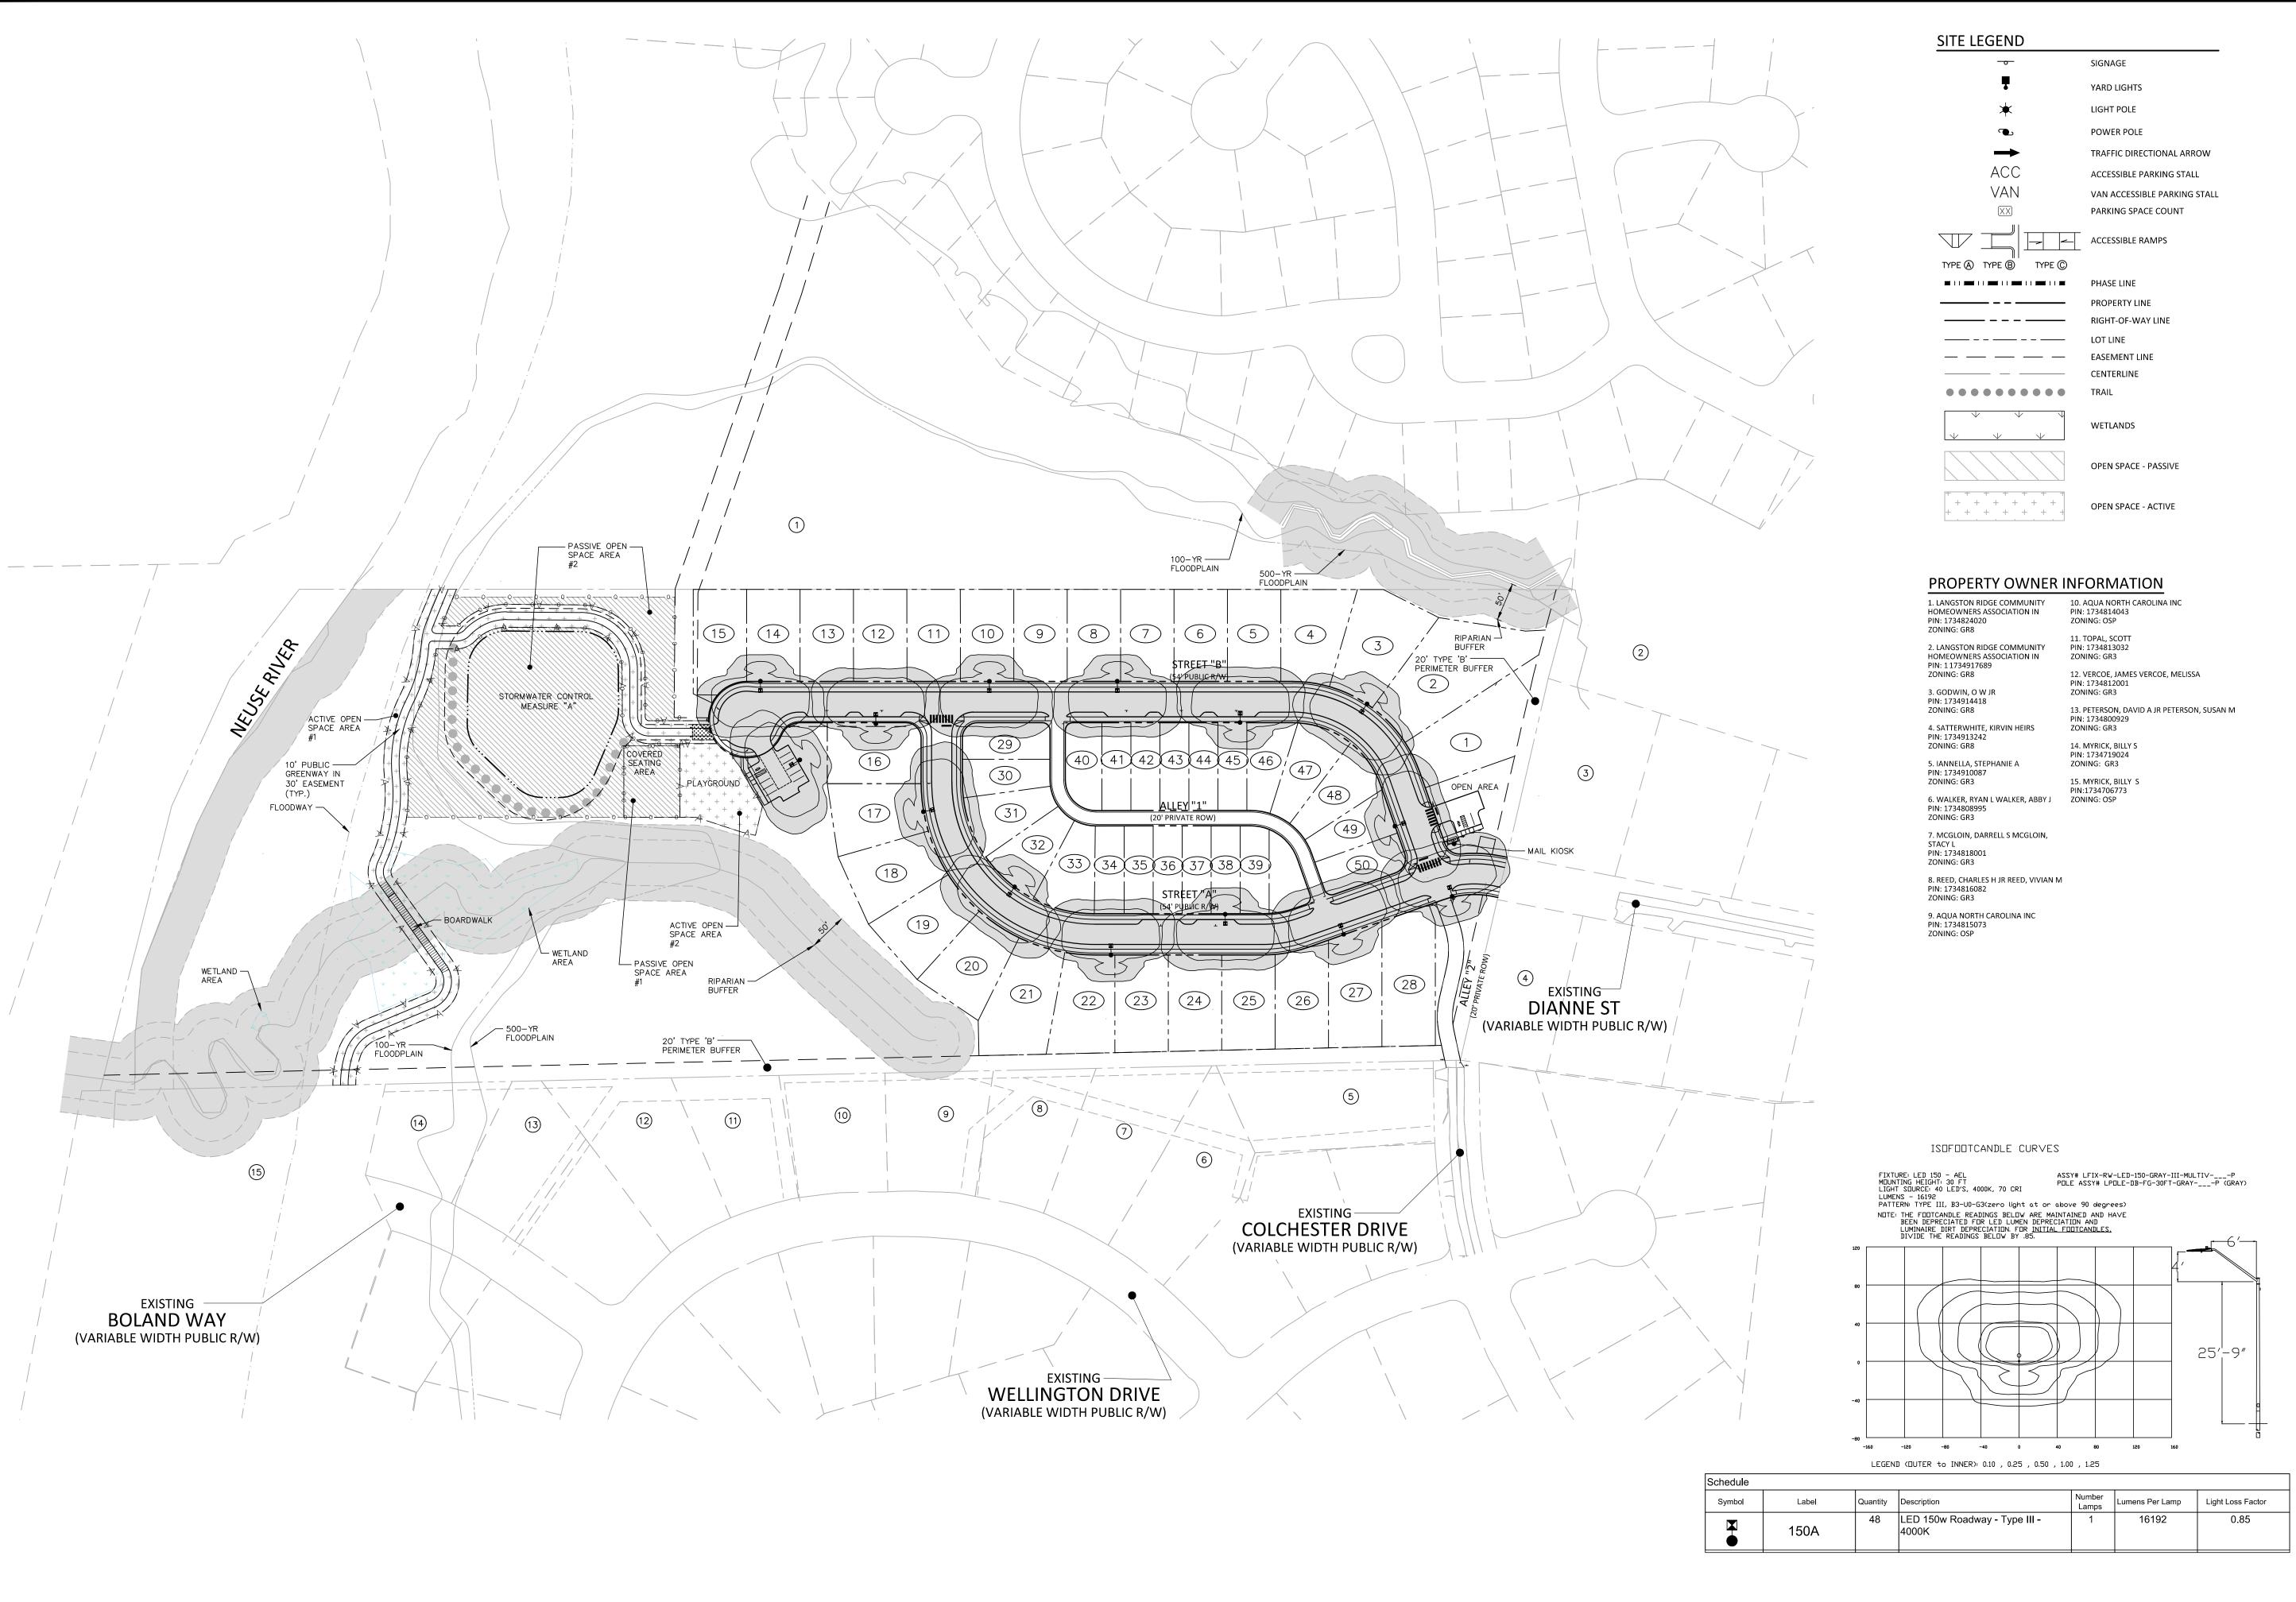
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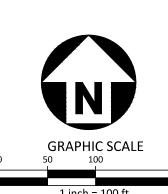
PROJECT NO. CDV21001 FILENAME CDV21001-LS1 CHECKED BY **DRAWN BY** SCALE AS SHOWN DATE 08. 22. 2022

SHEET

LANDSCAPE DETAILS

PRELIMINARY DRAWING - NOT RELEASED FOR CONSTRUCTION





PRELIMINARY DRAWING - NOT RELEASED FOR CONSTRUCTION



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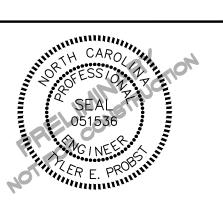
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MASTER PLAN AND 107 COLCHESTER DRIV KNIGHTDALE, NC 27545



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PLAN INFORMATION

PROJECT NO. CDV21001

FILENAME CDV21001-LI1

CHECKED BY JCM

DRAWN BY RJF/CNM

SCALE 1" = 100'

DATE SHEET

OVERALL LIGHTING PLAN

08. 22. 2022

L6.00



RIVER POINTE

Planned Unit Development Town of Knightdale AUGUST 22, 2022







TABLE OF CONTENTS

VISION + INTENT

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4. UNIFIED DEVELOPMENT ORDINANCE + KNIGHTDALENEXT 2035 COMPREHENSIVE PLAN CONSISTENCY

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- 5. **DESIGN GUIDELINES**Single-Family Architectural Standards
- 6. TRANSPORTATION ANALYSIS

Transportation Study Summary

7. RECREATIONAL OPEN SPACE + AMENITIES Open Space Standards

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Streets + Sidewalks Stormwater Water + Sewer

NEIGHBORHOOD MEETING REPORT Meeting Summary Question Log

RIVER POINTE

Planned Unit Development (GR3)
Prepared for The Town of Knightdale

Submittal Dates

First Submittal: 8/22/22

Second Submittal: 9/30/22

Third Submittal: 11/4/22

Developer

Carolina Development Group 10136 Mizner Lane Raleigh, North Carolina

McAdams Company, Design Lead 2905 Meridian Parkway Durham NC 27113





VISION + INTENT

VISION + INTENT

As stated in §2.4 (C) and 12.2 (F)(3)(g) of the Knightdale Unified Development Ordinance, the Planned Unit Development District is designed to encourage master planning of development so as to coordinate and manage the impacts of the development on the provision of Town Services and infrastructure. The Planned unit Development encourages creativity and innovation in the design of development, but in return for this flexibility the expectation is for communities to:

- > Provide exceptional design, character, and quality
- > Provide high quality community amenities with an emphasis on place making
- > Incorporate a creative and integrated design in the layout of buildings
- > Ensure compatibility with surrounding land uses and neighborhood character
- > Further the goals of the Comprehensive Plan including the growth framework and growth and conservation map
- > Provide greater efficiency in the layout and provision of roads, utilities, and other infrastructure.

THE RIVER POINTE PLANNED UNIT DEVELOPMENT MEETS THE STATED VISION AND INTENT OF THE PLANNED UNIT DEVELOPMENT AND GOALS OF ADOPTED PLANS AS FOLLOWS:

Provide exceptional design, character, and quality:

Homes within the proposed PUD will follow a set of prescribed architectural design standards which preserve the spirit and intent of the design requirements previously applicable in Chapter 5 of the Knightdale UDO (archived version). The proposed development provides exceptional site design, character, and quality through its mix of lot sizes and driveway access and the incorporation of its opens pace into the larger open space network to be created along the Neuse River. The design of signage and amenities shall embrace the 'River District' which Knightdale is in the process of developing.

Provide high quality community amenities:

This project is anchored by a HOA owned and maintained park nestled against the Neuse River public greenway. As proposed, this park space would provide a mixture of active and passive uses, while providing greater access to preserved natural open space and the Neuse River greenway trail. Planned amenities include an IPEMA certified playground, a picnic area with shade sails, public art, a play lawn, and both private and public greenway trails. Given the site's minimal number of lots (50 total), this represents a sizable amenity package.

Incorporate creative design in the layout of buildings:

The location of the proposed single family lots are designed to maximize preservation along the western portion of the site, and accommodate improved open spaces backing up to this preserved space. The internal block is designed as alley-loaded lots to create a more pleasing streetscape with less driveway breaks, as well as to accommodate limited on-street parking.

Ensure compatibility with surrounding land uses and neighborhood character:


In addition to providing perimeter buffers against abutting neighborhoods to the south and east, the proposed layout strategically locates it's largest lots (70' SFD lots) along it's perimeter while internalizing its narrower rear loaded product. This layout will create a more gradual transition of density from the proposed development to neighboring subdivisions.

Further the goals of the Comprehensive Plan including the growth framework and growth & conservation map:

The proposed development is identified by the Comprehensive Plan as being located within a Target Investment Area. Target investment areas are described as being within the existing corporate limits or ETJ with relatively easy potential access to both sewer and water. Future growth should be guided into more compact and efficient development patterns that will help manage the timing, location, and magnitude of expensive infrastructure investments. The adopted 'Growth and Framework' Map identifies this area as a 'Mixed-Density Neighborhood'. Both designations support a more compact and denser development pattern than the surrounding neighborhoods constructed under county regulations. However, to be sensitive to surrounding neighborhoods and based on staff feedback, we have limited this development to single-family detached homes.

Provide greater efficiency in the layout and provision of roads, utilities, and other infrastructure:

River Pointe is designed to be compact and efficient in its provision of infrastructure. While environmental features limit its external connections, this project will construct a portion of the Neuse River greenway trail and support greater access to this future pedestrian network.

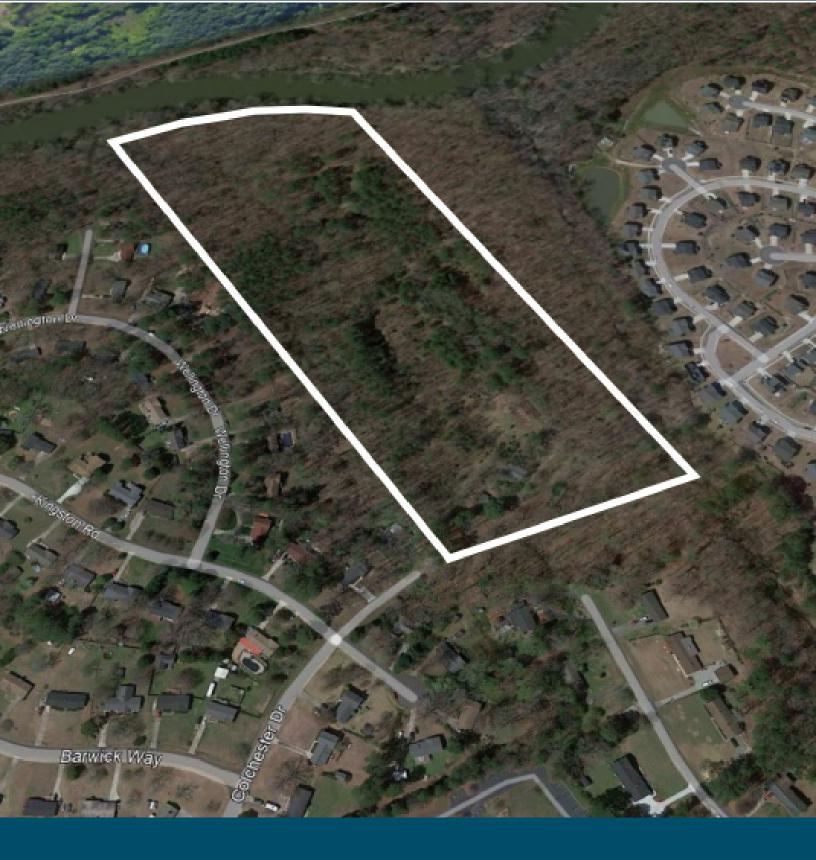


2 EXISTING CONDITIONS

EXISTING CONDITIONS SUMMARY

River Pointe is located on two parcels owned by Jane and Charles Knox, at the terminus of Dianne Street as it approaches the Neuse River to the west. (PIN # 1734813452 & 1734912203). The site is bordered by the Neuse River to the west, and a tributary of the Neuse river to the north. As such, the site is subject to floodplain, riparian buffers, and limited wetlands. The site borders existing subdivisions built under Wake County regulation to the south and east. Stands of trees occupy the majority of the site. In general, the site slopes to the west towards the Neuse river, but multiple streams (both on and off-site) create divergent drainage patterns to the north and internal to the site. The site has an existing Right-of-way stub in the form of Dianne Street to the east, as well as a partial stub to Colchester Drive to the south.


VICINITY MAP

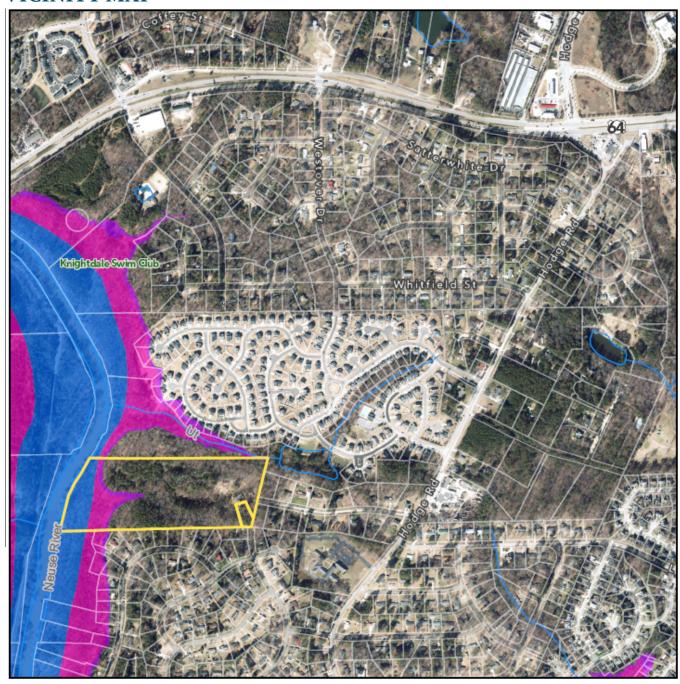





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ENVIRONMENTAL SURVEY

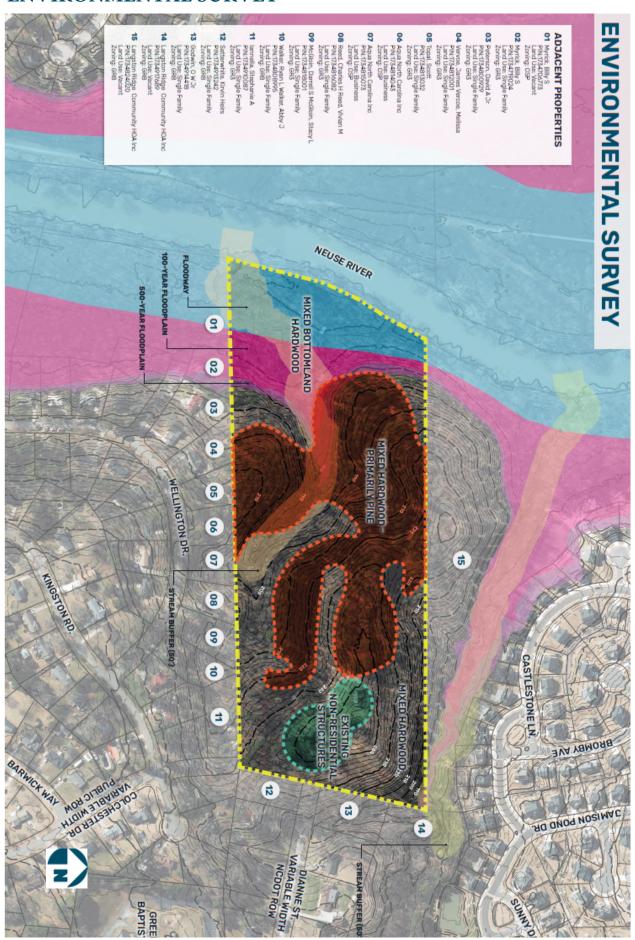

CURRENT ZONING MAP



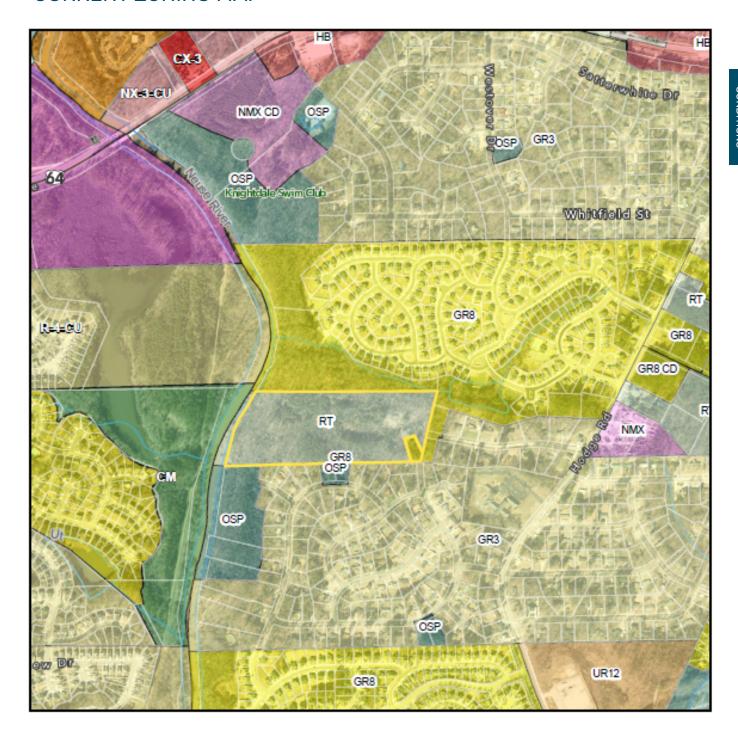

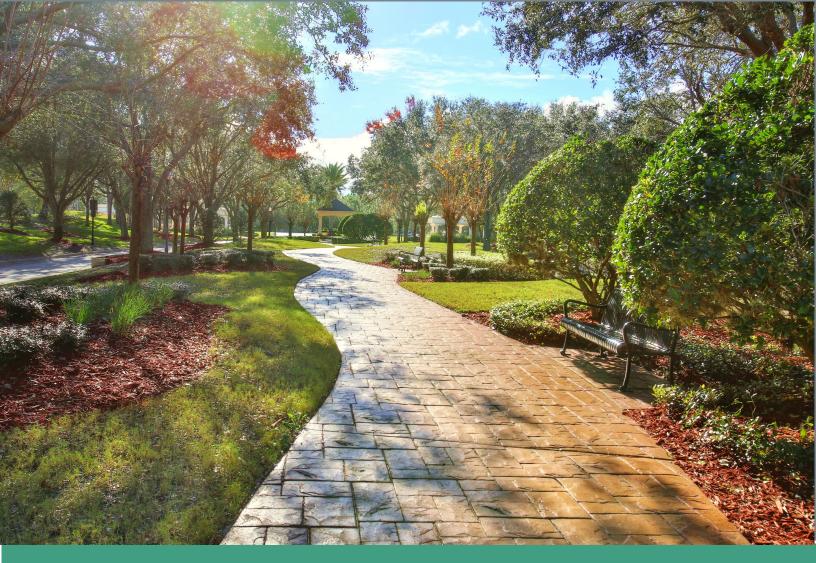3

PUD MASTER PLAN

PLANNED UNIT DEVELOPMENT MASTER PLAN

DEVELOPMENT DETAILS

River Pointe is a small residential community nestled against the Neuse River, consisting of 50 detached single homes. This development would be designed to the GR3 and Planned Unit Development standards of the Town of Knightdale Unified Development Ordinance. River Pointe will provide a mixture of large lot, front loaded homes along the exterior of the site and narrower rear-loaded single family homes within the interior of the site. River Pointe will provide a mixture of housing choices for Knightdale citizens, as well as well-designed and multi-functional recreational amenities positioned against the Neuse River Greenway trail.

DEVELOPMENT MIX

		Number of Units	Percentage of Development
•	Front loaded Single Family Dwellings	28	56%
•	Rear loaded Single Family Dwellings	22	44%







FRONT LOADED SINGLE-FAMILY DWELLINGS

MODIFICATIONS TO UDO STANDARDS

Section 3.4K of the Knightdale Unified Development Ordinance requires that any lot less than 80' in width be accessed via an alley or rear lane access. In order to reach a density needed support the required amenities and site improvements, Rive Point requests that this requirement be reduced to lots less than 70' in width. To ensure that the homes are of high-quality and add to the vitality of River Pointe and Knightdale as a whole, the applicant has offered tailored architectural standards as a condition of the zoning approval.

To create an interesting streetscape and encourage interaction between the public and private realm, front-loaded single-family dwellings in River Pointe will be served by driveways that are a minimum length of 25' rather than the UDO requirement of 35'. Furthermore, rear setbacks of 20' shall be applied rather than 25'.

FRONT LOADED SFD STANDARDS

Minimum lot sizeLot width (min.)7700 sf70'

> Front setback (min) 18' (25' for face of garage)

Minimum driveway length 25'

> Side setback (min) 5' (10' on corner sides)

Rear setback (min)Maximum building height3 stories




REAR LOADED SINGLE-FAMILY DWELLINGS

MODIFICATIONS TO UDO STANDARDS

In an effort to reduce the amount of impervious surface on the lots, and to increase the developable area on each parcel, rear-loaded single-family dwellings in River Pointe will be served by driveways that are a minimum length of 20' rather than the UDO requirement of 35'. Furthermore, rear setbacks of 15' shall be applied rather than 25'.

REAR LOADED SINGLE FAMILY DWELLING STANDARDS

	20, 22 0	
>	Min Lot Size	3800 SF
>	Min Lot Width	38'
>	Front Setback (min)	10'
>	Minimum Driveway length	20' (measured to edge of alley pavement)
>	Side Setback (min)	4' (10' corner side)
>	Side Setback aggregate (min)	8'
>	Rear setback (min)	15'
>	Min Building Height	3 stories

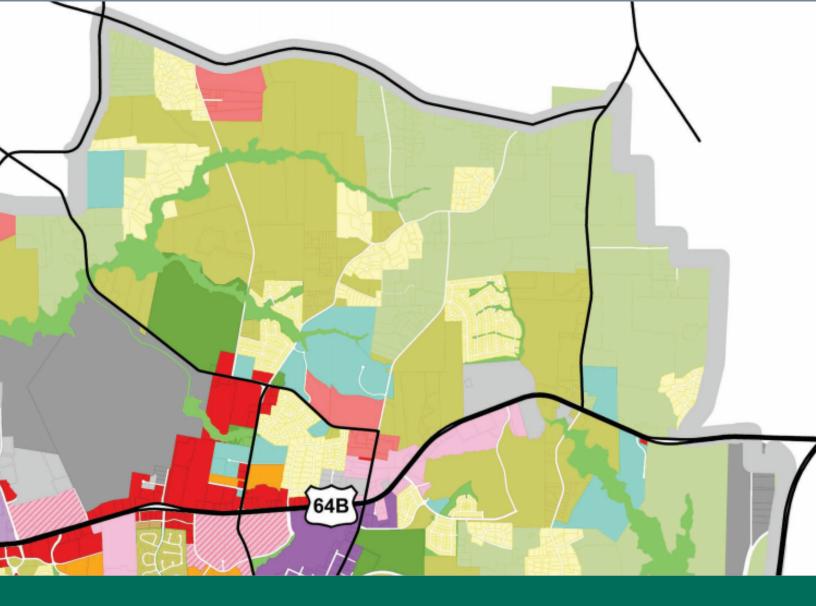

4 UDO + COMPREHENSIVE PLAN CONSISTENCY

UNIFIED DEVELOPMENT ORDINANCE CONSISTENCY

The River Pointe PUD has been designed to meet the requirements of the Unified Development Ordinance where practical and achievable. There are some instances where, due to site constraints or developer needs, it is not possible to meet the specific requirement of the Ordinance. In those instances, the applicant is proposing site development allowances that will meet the intent of the Ordinance while providing necessary flexibility. The requested modifications to the requirements of the UDO, and the proposed alternative methods of compliance, are listed below.

SITE DEV. ALLOWANCE FOR FRONT LOADED SINGLE-FAMILY DWELLINGS [INTEGRATED DESIGN] Section

3.4K of the Knightdale Unified Development Ordinance requires that any lot less than 80' in width be accessed via an alley or rear lane access. In order to permit a density necessary to support the site's required infrastructure and recreational improvements, River Pointe will include up to 28 single family units as front-loaded lots with a minimum 70' width (instead of 80'). The applicant has offered tailored architectural standards for these units as a condition of the zoning approval.

To create an interesting streetscape and encourage interaction between the public and private realm, front-loaded single-family dwellings in River Pointe will be served by driveways that are a minimum length of 25' rather than the UDO requirement of 35'. The proposed driveway length will still ensure that parked vehicles do not obstruct pedestrian movement on the adjacent sidewalk. The minimum front setback shall be 18' (or 25' at the garage). Furthermore, rear setbacks of 15' shall be applied rather than 25'. Minimum side setbacks shall be a standard 5' rather than a variable percentage in order to create consistency and easier administrative enforcement.

SITE DEV. ALLOWANCE TO REAR LOADED SINGLE-FAMILY DWELLINGS [INTEGRATED DESIGN]

In an effort to reduce the amount of impervious surface on the lots, and to increase the developable area on each parcel, rear-loaded single-family dwellings in River Pointe will be served by driveways that are a minimum length of 20' rather than the UDO requirement of 35'. Furthermore, rear setbacks of 15' shall be applied rather than 25'. Minimum side setbacks shall be a standard 4' rather than a variable percentage.

SITE DEVELOPMENT ALLOWANCE TO DISTRIBUTION OF USES [INTEGRATED DESIGN]

Section 11.1B of the Knightdale Unified Development Ordinance establishes a minimum and maximum required distribution of uses, calculated as the net development area which excludes street ROW and dedicated open space. Due to this site being a relatively small infill project surrounded by existing single-family subdivisions, Knightdale planning staff instructed the applicant to only propose single family detached homes. Earlier iterations of the sketch plan also included townhomes. As a result of this feedback, River Pointe requires an exception to the standard distribution of use requirement, to allow 100% single family dwellings.

SITE DEVELOPMENT ALLOWANCE TO CONNECTIVITY INDEX [INTEGRATD DESIGN]

Section 11.3E7 of the Knightdale UDO requires a minimum connectivity index of 1.4 for a GR3-PUD. Due to environmental features to the west and HOA owned and preserved open space to the north, River Pointe shall be permitted a minimum connectivity index of 1.3. Additional connections are infeasible due to environmental site constraints.

UNIFIED DEVELOPMENT ORDINANCE CONSISTENCY

SITE DEV. ALLOWANCE TO MASS GRADING (LOTS 60' WIDE OR MORE) [SURFACE WATER DRAINAGE]

Section 9.3 of the Knightdale UDO prohibits mass grading on all single family lots 60' or greater in width. As part of the PUD approval, River Pointe shall be permitted an exemption to this rule and will be allowed to mass grade all of its front-loaded lots. All rear-loaded lots within River Pointe are already exempt from this rule by code. Of the 28 front-loaded lots, 26 of them back up to a 20' Type B buffer, a natural riparian buffer, or an HOA owned and maintained natural open space. The remaining 2 lots back up to recreational open space within River Pointe.

This exemption would allow for a far more efficient construction process and support more consistent grading and drainage management between adajcent lots, while still offering significant vegetation near the site's largest lots. The exhibit below illustrates those areas where the deviation to the Town's mass grading rules would apply.



KNIGHTDALENEXT 2035 COMPREHENSIVE PLAN CONSISTENCY

River Pointe is generally consistent with the Town of Knightdale's Growth Framework Map and Growth and Conservation Map.

Currently, the Growth Framework map included in the KnightdaleNext 2035 Comprehensive Plan identifies the project site as falling with the Target Investment Area. Target Investment Areas are defined within the Comprehensive Plan as land within the current Town limits as well as closely surrounding land in the current ETJ that has existing or relatively easy potential access to both sewer and water.

The Growth and Conservation map identifies this area as falling with the Mixed Density Neighborhood place-type category. Mixed Density Neighborhoods call for a mix of housing types and densities. Lots along the perimeter of a new neighborhood should be sensitive to the density observed along the perimeter of an adjacent neighborhood in terms of size and scale. River Pointe provides this housing mix through a combination of smaller rear-loaded homes within the project center and larger front-loaded homes along the project perimeter.

Furthermore, River Pointe is consistent with the following Guiding Principles in the KnightdaleNext 2035 Comprehensive Plan ("KCP"):

- 1. Great Neighborhoods and Expanded Home Choices: This principle aims to promote vibrant neighborhoods that "provide greater access to a range of housing choices people need at different stages of their life." (KCP p. 17). This principle also notes that "new neighborhoods should mix two or more housing choices into one community." (KCP p. 17). River Pointe provides a mix of narrow alley-loaded homes and larger front-loaded homes to accommodate different housing needs.
- 2. Transportation: This guiding principle aims to "provide a safe, reliable, and integrated transportation system that balances all modes of transportation, including walking, biking, public transit, and cars" (KCP p. 15). This project includes includes a proposed public greenway along the Neuse River, representing a critical link in a future comprehensive greenway system to be established as part of Knightdale's desired River District.
- 3. Natural Environment: This principle seeks to promote and expand opportunities for people to experience natural settings in Knightdale, increase their proximity to multiple recreational opportunities, and enjoy a safe and healthy lifestyle. It further aims to safeguard the Town's natural resources including lakes, streams, wetlands, woodlands, trails, agricultural lands, tree canopy, and the services they provide. River Pointe preserves a significant amount of riparian buffer, floodplain, wetlands, and tree canopy. The proposed layout is designed to avoid vehicular stream crossings. Furthermore, this site will facilitate access to the Neuse River and a future greenway trail extension for residents and neighboring community members alike.
- 4. Community Design: This principle aims to celebrate a distinct brand and sense of place that is uniquely Knightdale by creating a certain vibe, identity, and reputation for Knightdale as a place for pedestrians and active public spaces. Through it's trail system, signage, proposed artwork, and branding, River Pointe seeks to cultivate a design and feel that is rooted within the 'River District' theme with the Town is looking to establish along the Neuse.
- 5. Parks and Recreation: This principle aims to "promote and expand opportunities where people can be more involved in an active community lifestyle represented, in part, by the presence of high quality parks, public spaces and recreation facilities located near where people live." (KCP p.15). As illustrated in the conceptual master plan, River Pointe will incorporate both public and private pedestrian trails, a playground, recreational lawn, and a covered seating area all nestled against the future Neuse River Greenway trail.



5 DESIGN GUIDELINES

SINGLE-FAMILY DWELLING ARCHITECTURAL STANDARDS




<u>Note</u>: Image above is an example elevation of a front-loaded home, which fits the architectural standards below. Actual elevations to be built as part of this project are pending and will be provided once a builder is under contract.

- 1. All Single Family houses shall have a 2 car garage.
- 2. All front entrances shall be raised from the finished grade (at the frontage line) a minimum of 18 inches in height and be wrapped in masonry veneer.
- 3. Foundations shall be raised slabs, stem wall, or crawls 18" in height and wrapped on all sides in masonry veneer
- 4. All single-family houses shall have either a usable front porch or stoop with a minimum depth of 6 feet.
- 5. Wall materials shall be limited to a combination of wood clapboard, cementitious fiber board, shingle/ shake, drop siding, primed board, wood board and batten, brick and/or stone.
- 6. Front facades shall be comprised of a minimum of two (2) of the listed wall materials, one of which shall be brick or stone (not including foundation).
- 7. Roof Materials may be comprised of the following: standing seam metal, asphalt shingles, copper, or wood shingles. Roofs shall feature multiple breaks.
- 8. No vinyl siding shall be permitted. Vinyl trim and soffit are permitted.
- 9. Principle roofs shall have a pitch between 6:12 and 12:12
- 10. Eaves shall project 8-12".
- 11. On front-loaded units, garage doors shall not exceed 45% of the corresponding facade's total width. All front-loading garage doors shall contain window inserts and carriage style adornments.
- 12. The following minimum square footages shall apply to all homes:
 - a. Front-loaded homes: 2200 sq. ft min.
 - b. Rear-loaded homes: 1700 sq. ft min.

REAR LOADED SFD EXAMPLE ELEVATION



<u>Note</u>: The image above is an example elevation of a rear-loaded home which fits the architectural standards included in this application. Actual elevations to be built as part of this project are pending and will be provided once a builder is under contract.

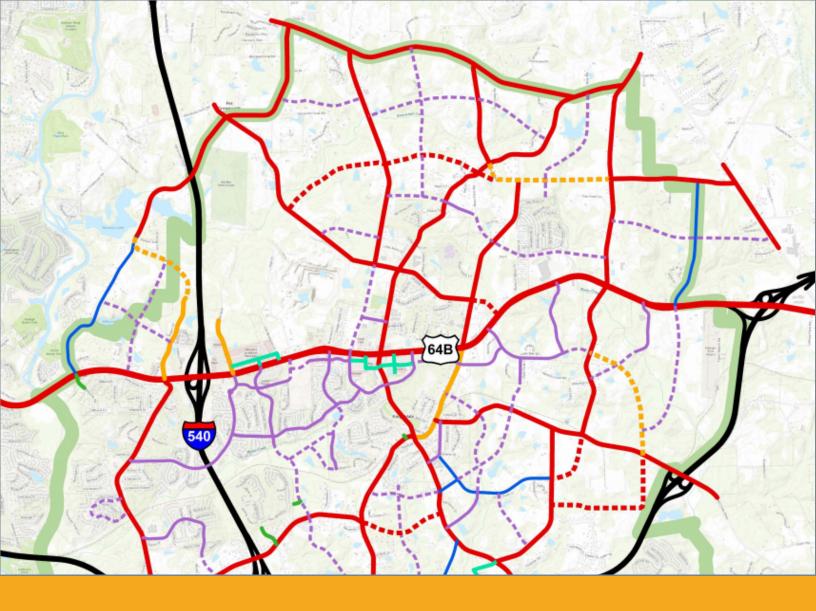

6 TRANSPORTATION ANALYSIS

RANSPORTATION

TRANSPORTATION IMPACT SUMMARY

The Town of Knightdale requires a Traffic Impact Analysis (TIA) to be conducted for any development which generates 150 peak hour trips. With only 50 SFD lots, the proposed River Pointe development only generates 33 weekday PM peak hour trips - well shy of the required threshold. However, due to this site's location behind an existing subdivision accessed via Dianne Street, the applicant voluntarily had a traffic assessment memo prepared by Ramey Kemp estimating the trip generation and providing a planning level review of existing roadways and anticipated site impacts. A full copy of the Traffic Assessment memo will be submitted for review and approval with the PUD submittal. A summary of that analysis is provided below for reference.

Trip Generation

Land Use (ITE Code)	Intensity	Daily Traffic (vpd)	Weekday AM Peak Hour Trips (vph)		Weekday PM Peak Hour Trips (vph)	
			Enter	Exit	Enter	Exit
Single-Family Detached Housing (210)	50 units	533	10	30	33	19

Road Name	Route Number	Typical Cross Section	Speed Limit	Maintained By	2019 AADT (vpd)	Daily % Added Traffic by Colchester Drive Development
I-495	·	6-lane divided	70 mph	NCDOT	88,500	<1%
1-540)	6-lane divided	70 mph	NCDOT	55,000	<1%
Knightdale Boulevard	US 64 BUS	6-lane divided	45 mph	NCDOT	31,500	<1%
Hodge Road	SR 2516	2-lane undivided	35 mph / 45 mph	NCDOT	9,900	~3%

Transportation Findings

Based on the trip generation and planning level review of the surrounding network results, it is expected that the proposed River Pointe residential development will have minimal impact on the surrounding roadway network. Based on the low anticipated turning movements volumes and based on other developments in the area of similar size, no turn lanes are recommended to be provided by the developer. The existing roadway network is expected to accommodate the future traffic volumes associated with the proposed River Pointe residential development.



7 RECREATIONAL OPEN SPACE + AMENITIES

RECREATIONAL OPEN SPACE AND AMENITIES


River Pointe will provide a diverse offering of active and passive recreation areas within the development as detailed below, linked by a network of private and public greenway trails.

Open Space Standards

Total recreation open space required:
 Active recreation space required:
 Active recreation space provided:
 1.045 Acres
 1.10 Acres

Passive recreation space required: 1.045 Acres
 Passive recreation space provided: 2.12 Acres
 Additional common open space: 7 Acres

River Pointe's programmed open space will be anchored by neighborhood park nestled against the future neuse river greenway extension. This development will construct the first leg of the neuse river greenway trail in this area along it's western boundary, including a pedestrian stream crossing of a smaller tributary. This neighborhood park, which shall be designed to adhere to the Town's desired 'River District' theme, shall include a playground/tot lot, a covered seating area with shade sails, private and public pedestrian trails, parking, an amenitized SCM with a fountain, public art, and a recreational lawn.

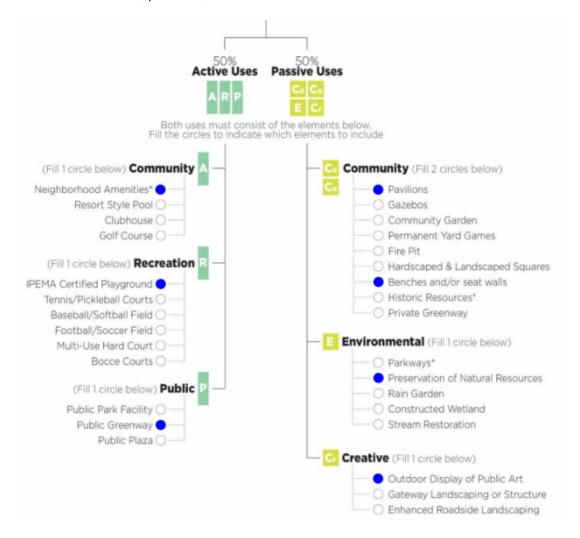

Public Greenway Wayfinding

Since River Pointe will provide a new connection to the Town's desired Neuse River Greenway Trail, effective wayfinding will be needed to direct residents and visitors to this important public amenity.

Final greenway signage designs will be coordinated with Town of Knightdale staff during the construction drawing phase of this project. However, the images below represent the applicant's vision of effective wayfinding signage which complements established greenway signage, while applying Knightdale's unique branding.

Trail Head Sign Concept



Directional Sign Concept





8 INFRASTRUCTURE

STREETS + SIDEWALKS

Streets and alleys within River Pointe are designed to meet the standards of the Town of Knightdale.

- The extension of Dianne Street will be constructed per the Town of Knightdale's Local Street Standards. A transition area will be required where the existing DOT road terminates and the new local road extension begins.
- To improve emergency access, a 30 ft. wide access easement shall be provided between River Pointe's internal road network and the existing Colchester Drive ROW.

STORMWATER

River Pointe is located within the Neuse River basin with the site's stormwater runoff draining towards the Neuse River to the west. The proposed development shall be subject to stormwater management requirements found in Chapter 9: Environmental Protection Standards of the Town of Knightdale's Unified Development Ordinance (UDO). Per regulations established in Chapter 9 of the Town of Knightdale's UDO, stormwater runoff provisions shall address peak flow mitigation and water quality management.

One above ground stormwater control measure (SCM) is proposed to meet regulations established Chapter 9 of the Town of Knightdale's UDO by providing peak flow mitigation and water quality management for the site. Additionally, this SCMs will be designed to have a minimum of 85% avg. annual removal for Total Suspended Solids (TSS).

WATER + SEWER

- > Water and sewer within River Pointe are designed to meet the standards of the City of Raleigh.
 - All sewer mains within the development will be 8" diameter minimum
 - A water system analysis will be submitted at the time of construction drawing submittal to determine water main sizes within the development.



9 NEIGHBORHOOD MEETING REPORT

NEIGHBORHOOD MEETING REPORT

RIVER POINTENEIGHBORHOOD MEETING

July 28, 2022, 6:00 pm Online Zoom Webinar Format

A neighborhood meeting was held on June 28, 2022 at 6:00pm. Due to Covid-19, this meeting was held remotely via a Zoom Webinar. There were 25 total attendees (including presenters) representing adjacent property owners. A complete log of the participants and questions posed are contained on the following pages. A summary of the number of comments received by category is also provided, with questions related to traffic and utilities being the only categories receiving 3 or more comments.

Presenters:

- 1. David Bergmark (McAdams)
- 2. Tyler Probst (McAdams)
- 3. Kevin Lewis (Town of Knightdale)
- 4. Mary Lynn Smith (Ramey Kemp)

Additional Attendees:

- 1. Mark Puryear (Developer)
- 2. Heather Mosesso (Knightdale Planner)
- 3. Jennifer Brady [105 Dianne St]
- 4. Derek and Stacey Thompson [109 Dianne St]
- 5. Scott and Stacy McGloin [213 Wellington Dr]
- 6. Timothy Ballard [217 Wellington Dr]
- 7. Dianne Thompson [112 Dianne St]
- 8. Patricia & Steven Bauer [109 Wellington Dr in Barclay Downs]
- 9. Joe Foster
- 10. Sean and Joanna Sanford [101 Dianne St]
- 11. Presley [201 Barwick Way]
- 12. Duane Smith
- 13. Trisha
- 14. Stephanie lannella [100 Colchester Drive]
- 15. Kathy Prue
- 16. Dan McVay
- 17. Robyn

7/28/22 RIVER POINTE NEIGHBORHOOD MEETING QUESTION LOG

- Scott have any soil borings been done? Concerned about rock. Lots of well water here
 and concerned about impacts to the aquifer. [Environmental Impact]
 - Response: there have been preliminary borings conducted on site. The report did not highlight anything glaring, and construction teams would have to follow all professional standards.
- Jennifer Brady asked about home sales price for the proposed development [Home Price/Value]
 - Response: though this could be subject to change, the developer is expecting rear loaded homes to sell in the lower to mid \$400k and front-loaded homes to sell in the mid to high \$400k.
- Patricia & Steven Bauer asked to receive notice of any additional neighborhood or public meetings. [Communication]
 - Response: adjacent property owners will receive notice from the Town at the time
 of the public hearing. Also, public meeting agendas will be posted, so you can watch
 out for that. Finally, if you want to email me and request notification, I can put a
 reminder on my calendar to email you notice of the meeting.
- Jennifer Brady will a turn lane be added to Hodge Road? [Traffic]
 - Response: we conducted a preliminary analysis of traffic and did not find a turn lane warranted in our opinion. However, our analysis is subject to review by the Town and that review is still pending.
- Duane expressed concerns about traffic. [Traffic]
 - Response: David Bergmark referenced the applicant's response to Jennifer Brady's question about traffic above.
- Dianne Thompson how will Dianne street hold up to construction traffic [Traffic]
 - Response: There will be field visits by DOT as construction goes on, including postconstruction inspections.
- Trisha asked if the site was not in the floodplain [Environmental Impact]
 - Response: the western portion closest to the Neuse is in the floodplain, but not the area we would be developing for lots or using as improved park space.
- Stephanie Iannella does this mean Colchester Drive will not be used for Construction Access? [Traffic]
 - Response: Correct. There are no plans to use Colchester Drive for Construction Access. Currently we only have an emergency access point shown there for EMS/fire access post-construction.
- Denita which street will be used as a construction entrance and staging construction equipment and materials? [Traffic]
 - Response: Dianne St would be used for access. Staging would occur internal to our site.

- Jennifer Brady will you be running city water down Dianne street? [Water/Sewer]
 - Response: One option is to bring water down Dianne street along the right-of-way (ROW). If we were to bring water down Dianne street, that would be within the ROW. There is a 60' ROW existing from DOT, so our goal is for everything to be within that. In terms of dry utilities, we would have to work with them, but that would be entirely within the ROW.
- Sanford asked if utilities will run down Dianne street. [Water/Sewer]
 - Response: The applicant referenced the response provided to Jennifer Brady above.
- Denita Are there plans for the city of Knightdale to annex Barclay Downs [Annexation]
 - Response: No. No forcible annexation is proposed. Someone could petition for annexation If they wished (if wells went bad, etc.), but only voluntary annexation is proposed.
- Jennifer brady What about sewer? Would sewer run down Dianne Street? [Water/Sewer]
 - Response: Our project would be on municipal sewer. Since our site is lower than Dianne Street, we would be looking at downhill options (not using Dianne St).
- Derek and Stacey would there be any planned improvements to Dianne St [Traffic]
 - Response: Dianne street is a DOT owned and maintained street. Any improvements would have to be both approved by and maintained by DOT. We have no planned improvements to Dianne Street.
- Sanford Who is going to run this by DOT? [Traffic]
 - Response: Knightdale would coordinate with DOT as development review occurs.
- Derek and Stacey What are the proposed lot size in acreage? [Density]
 - Response: approximately 0.2 acres for the front-loaded lots and 0.1 acres for the rear-loaded lots.
- Denita is any trail going to connect to Barclay downs? [Amenities]
 - Response: our plan only has the public greenway trail extending to our property line.
 We are not proposing any off-site trails.
- Scott there are four houses impacted by this type "b" buffer. One on Colchester and three
 on Wellington. This really needs to be a type "c" or "d" buffer. Twenty foot is not enough in
 my opinion. [Buffers/Landscaping]
 - Response: per Knightdale's code, no landscaped buffer is required. However, we are proposing a 20' buffer as that is typical for a planned unit development. We can discuss your concerns with the developer.
- Sanford What are the plans for school buses to enter Dianne St? None currently do, but I
 can see how this will change since children would have a lot further to walk to the closest
 bus stop. [Traffic]
 - Response: that would be a school board decision. We are required to notify the school system of our development so that they can make any necessary adjustments to their plans or facilities, but the school board would make decisions about bus stop locations.

- Jennifer Construction asked when construction would start, under the best-case scenario.
 [Timing]
 - Response: The schedule is still subject to change, but we envision site work beginning next Summer (summer of 2023) and homes going vertical in the summer of 2024.
- Derek expressed traffic concerns to the Town of Knightdale given the additional traffic this site would generate. [Traffic]
- Sanford expressed concerned about noise. Stated he could already hear vehicular noise from existing traffic. [Traffic/Noise]
 - Response: if annexed, this property would be subject to the Town's noise ordinance.
- Trisha I wonder if the speed limit may need to be dropped lower since the # of accidents is high [Traffic]
 - Response: Kevin Lewis stated that Knightdale is reviewing roads across town to see if any speed reductions are needed.
- David Peterson Are there any plan for a second phase in the woods? [Phasing/Additional Development]
 - Response: there are no plans for a second phase in the woods. Most of the woods
 are in the floodplain, so development there would not be possible. Furthermore,
 our development plan approval would lock in the expectations of areas to be
 developed vs. preserved. A change of that magnitude would require a new
 development proposal, public hearing, and approval by the Town.

NEIGHBORHOOD MEETING MAILING LIST (200 FT BUFFER)

Property Owner	Address 1	Address 2
AGUILAR, TEODULO MEJORADO, KIMBERLY	1104 EMERSON LAKE DR	KNIGHTDALE NC 27545-6398
AQUA NORTH CAROLINA INC	202 MACKENAN DR	CARY NC 27511-6447
BALLARD, TIMOTHY R	217 WELLINGTON DR	KNIGHTDALE NC 27545-9542
CLARK, KIMBERLY	103 KINGSTON RD	KNIGHTDALE NC 27545-9548
DREYER, ERICH ANTHONY	1004 EMERSON LAKE DR	KNIGHTDALE NC 27545-6397
FUNSHO, ZAINAB FUNSHO, HAMMID	1106 EMERSON LAKE DR	KNIGHTDALE NC 27545-6398
GARRIS, JENNIFER	102 COLCHESTER DR	KNIGHTDALE NC 27545-9536
GODWIN, O W JR	1714 LAKES HORE DR	DUNN NC 28334-2614
HENRY, MEAGAN BRIANNE	103 BOLAND WAY	KNIGHTDALE NC 27545-9559
HOLLOWAY, DAVID K HOLLOWAY, JULIA D	1008 EMERSON LAKE DR	KNIGHTDALE NC 27545-6397
IANNELLA, STEPHANIE A	100 COLCHESTER DR	KNIGHTDALE NC 27545-9536
KELLEY, JOHN C KELLEY, SUSAN C	1006 EMERSON LAKE DR	KNIGHTDALE NC 27545-6397
KNOX, JANE H	1509 CASWELL ST	RALEIGH NC 27608-2309
KNOX, JANE HKNOX, CHARLES R	1509 CASWELL ST	RALEIGH NC 27608-2309
LANGSTON RIDGE COMMUNITY HOMEOWNERS ASSOCIA	PO BOX 99657	RALEIGH NC 27624-9657
LAURORE, JOSHUA EMMANUEL CAMARON LAURORE, AD	1008 JAMISON POND DR	KNIGHTDALE NC 27545-6395
LI, GUOGANG	13605 POSSUM TRACK RD	RALEIGH NC 27614-9375
MATTOX, JILL WILSON, WAYNE W	101 KINGSTON RD	KNIGHTDALE NC 27545-9548
MCGLOIN, DARRELL S MCGLOIN, STACY L	213 WELLINGTON DR	KNIGHTDALE NC 27545-9542
MYRICK, BILLYS	3120 HODGERD	KNIGHTDALE NC 27545-8700
OWENS, CHRISTOPHER RYAN OWENS, AMANDA	1102 CASTLESTONE LN	KNIGHTDALE NC 27545-5116
PETERSON, DAVID A JR PETERSON, SUSAN M	102 BOLAND WAY	KNIGHTDALE NC 27545-9559
PRUE, BENJA MIN C PRUE, JOHN C	100 BOLAND WAY	KNIGHTDALE NC 27545-9559
RALEIGH CITY OF	PO BOX 590	RALEIGH NC 27602-0590
REED, CHARLES HJR REED, VIVIAN M	211 WELLINGTON DR	KNIGHTDALE NC 27545-9542
RILEY, DANNY W RILEY, AURORA S	202 KINGSTON RD	KNIGHTDALE NC 27545-9549
SATTERWHITE, KIRVIN HEIRS	115 DIANNE ST	KNIGHTDALE NC 27545-9530
SIMPSON, MELISSA ANN SIMPSON, TERRON HORATIOUS	1102 EMERSON LAKE DR	KNIGHTDALE NC 27545-6398
SMITH, FRANZ DUANE	113 DIANNE ST	KNIGHTDALE NC 27545-9530
TOPAL, SCOTT	205 WELLINGTON DR	KNIGHTDALE NC 27545-9542
VERCOE, JAMES VERCOE, MELISSA	203 WELLINGTON DR	KNIGHTDALE NC 27545-9542
WALKER, RYAN L WALKER, ABBY J	215 WELLINGTON DR	KNIGHTDALE NC 27545-9542
WILLIAMS, DENNIS WILLIAMS, ADELYA J	1104 CASTLESTONE LN	KNIGHTDALE NC 27545-5116
WRIGHT, STEPHEN N.	1010 JAMISON POND DR	KNIGHTDALE NC 27545-6395