

Meeting Minutes

EP Mart #10

Kimley-Horn # 017311002

Subject: Minutes from Neighborhood Meeting

To: Kevin Lewis (Town of Knightdale Planning)

CC: Yvonne Jones (EP Mart)

Date: April 5, 2022 Completed by: Chris Bostic

Attendees:

Yvonne Jones EP Mart
Audrey Shearin EP Mart
Chris Bostic Kimley-Horn

Kevin Lewis Town of Knightdale
Dustin Tripp Town of Knightdale

This memorandum summarizes the author's understanding of the discussions from the above referenced meeting.

General: The purpose of the neighborhood meeting was to discuss the proposed rezoning application for EP Mart #10 in Knightdale, NC with adjacent property owners. All property owners within 200 feet of the property were mailed the attached notification letter. The neighborhood meeting was held virtually on Microsoft Teams at 5:00 PM on April 5, 2022. The meeting opened at 5 pm. No one from the public joined the meeting.

End of Meeting



March 15, 2022

Dear Knightdale Area Property Owner:

You are invited to a neighborhood meeting to learn more about a proposed project adjacent to or near your property. A Neighborhood Meeting is required by the Town of Knightdale Unified Development Ordinance and all property owners within 200 feet of the proposed development must receive notification of the meeting. The meeting will be an opportunity for residents and property owners to learn more about the project and provide feedback.

Meeting Date: April 5, 2022 Meeting Time: 5:00 pm

Meeting Welcome: <u>5 pm</u> Project Presentation: <u>5:10 pm</u>

Q&A: 5:30 pm

Meeting Location: 340760667@t.plcm.vc Video Conference ID: 111 149 260 8

Or call in (audio only) +1 984-204-1608,,424327261# Phone Conference ID: 424 327 261#

Application type: Planned Unit Development

Approving Authority: Town Council Legislative Approval

Address: 7604 Knightdale Blvd, Knightdale, NC 27545

PIN: 1754558995

Description of proposal: Conditional Use Rezoning to allow for construction of Convenience Store with

<u>Fuel Sales</u>

Estimated Submittal Date*: April 25, 2022

Enclosed is a map showing the location of the property being considered for this proposal. Additional materials and information may be available at the meeting. *Please see the Development Services 2022 Meeting & Submittal Schedule

(https://www.knightdalenc.gov/sites/default/files/uploads/DevelopmentServices/submittal_and_meeting_schedule_2022.pdf) for future public meetings date


If you have any questions, comments, or concerns about the proposal prior to the meeting, you may contact the project manager, Yvonne Jones at (252) 445-6606, or <u>yjones@epmart.com</u>. These will be recorded as part of the meeting summary, which is submitted to Town staff and elected officials. You may also contact Kevin Lewis with the Town of Knightdale Development Services Department at kevin.lewis@knightdalenc.gov or 919-217-2243.

Cc: Town of Knightdale Development Services Department

LETTER SUBMITTAL MAP



Note: Parcel Key can be found on next page

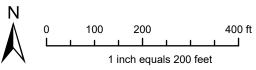



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Parcel Key

- 1. KNIGHTDALE RA LLC. PIN 1754564381
- 2. DVM SERVICES REALTY LLC, PIN: 1754566374
- 3. M. M. FOWLER INC, PIN: 1754569434
- 4. SHERWOOD FREEMAN PROPERTIES LLC, PIN: 1754660564
- 5. POOLE, JAMES HOWARD JR, PIN: 1754662606
- 6. MONEY COURT PROPERTY HOLDING LLC, PIN 1754662151
- 7. WAKE COUNTY BOARD OF ALCOHOLIC CONTROL, PIN: 1754652913
- 8. WAKE HOSPITALITY INC, PIN: 1754652794
- 9. JERRY GOWER CONSTRUCTION CO INC, PIN: 1754652548
- 10. CORNER OFFICE LLC, PIN: 1754651510
- 11. LOCKE, CHARLOTTE C, PIN: 1754558634
- 12. SUGGS, JANE P BEASLEY, EVE C, PIN: 1754450090
- 13. R B PERFORMANCE SALES AGENCY INC, PIN: 1754555926
- 14. R B PERFORMANCE SALES AGENCY INC, PIN: 1754555813
- 15. LOCKE, L W LOCKE 2 LLC, PIN: 1754558995


EXISTING ZONING MAP




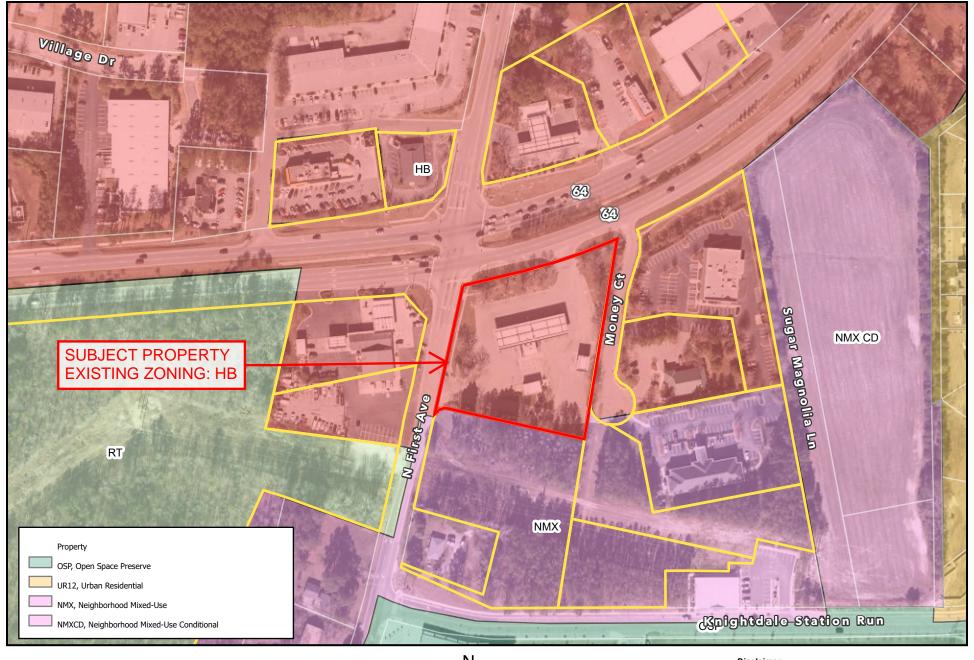
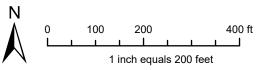
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PROPOSED ZONING MAP



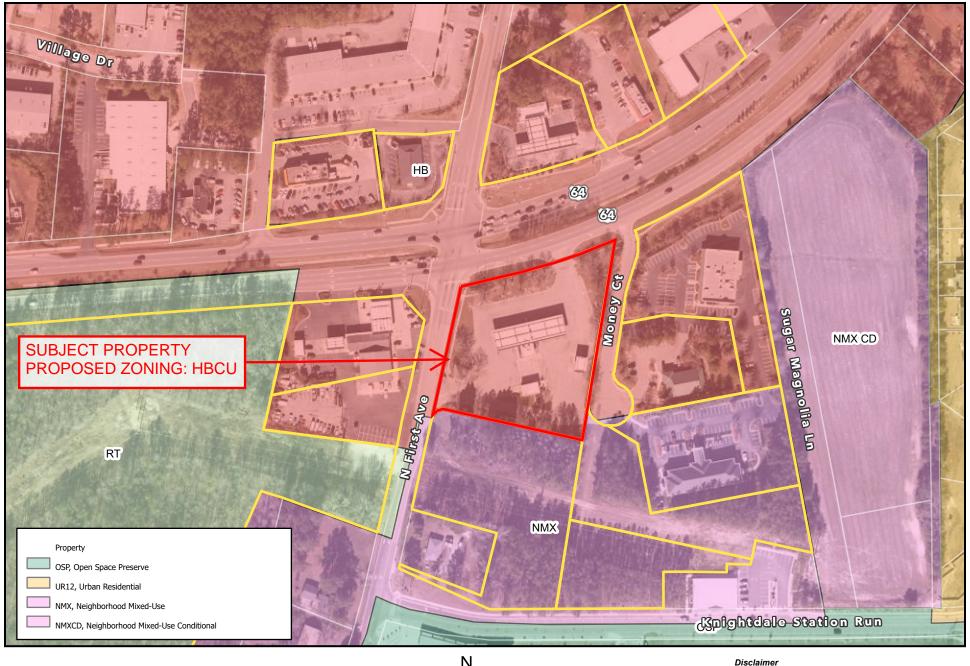
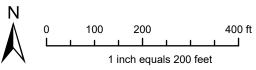
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Project Contact Information

Project Name: EP Mart	_ Proposed Zoning: HBCU
Location: 7604 Knightdale Blvd, Knightdale, N	C 27545
Property PIN(s): 1754558995	
Property Owner: Eastern Petroleum Corporati	
Address: PO Box 398	
City: Enfield State:	NC Zip: 27823
Phone: 252-445-6606	
Developer: Same as above	
Address:	
City:State:	Zip:
Phone:	_Email:
Engineer: Kimley-Horn	
Address: 421 Fayetteville Street, Suite 600	
City: Raleigh State:	NC _{Zip:} 27601
Phone: 919-653-2927	
Builder (if known):	
Address:	
City:State:	
Phone:	Email:



Neighborhood Meeting Agenda and Project Details

The neighborhood meeting for the proposed EP Mart will begin with a brief introduction and welcome (5:00-5:10), followed by a presentation of the project (5:10-5:30) and a period afterwards for Q&A and comments (5:30-6:00). The developer, engineer and Town of Knightdale Staff will be present to help answer questions and receive comments about the development. Based on feedback from this meeting and meetings with Town staff, the project design will be submitted to the Town. The project will be present at an upcoming Town Council public hearing, subsequently reviewed by the Land Use Review Board, and again by the Town Council.



Electronic Neighborhood Meeting Guidelines

In response to the COVID-19 pandemic, the Town of Knightdale Development Services Department has established this set of guidelines for compliance with <u>UDO Section 15.3.C</u> regarding Neighborhood Meetings. An Electronic Neighborhood Meeting is only permitted during times of limited group gatherings, as a means of compliance with UDO regulations, and to ensure proposals remain on a relatively normal timeline.

Why are Neighborhood Meetings required?

UDO Section 15.3.C requires a Neighborhood meeting prior to the submittal of any Zoning Map Amendment or Special Use Permit. The goal is to solicit feedback from neighboring residents to assist in bettering the proposal prior to the required public hearing. Applications for proposals must be submitted within six (6) months of the meeting (Sec 15.3.C.1); failure to submit within this time will require a subsequent meeting.

Roles and Responsibilities

All stakeholders will be given the opportunity to speak and provide constructive comments, ask clarifying questions, and make realistic suggestions to contribute to the development of Knightdale. The conversation should remain respectful; disruptive behavior will not be allowed. The roles of all participants are defined below.

- ☐ Facilitator Assistant Town Manager
 - Ensures meeting efficiency and maintains order
 - Ensures accurate description of proposal
 - Allows for constructive comments/questions
 - Receives and documents questions for staff and/or developer
- ☐ Staff Liaison Development Services Staff Member
 - Listens to and records comments/questions
 - Answers process and ordinance related question
- ☐ Developer Applicant and Development Team
 - Presents the project accurately
 - Listens to and records comments/questions
 - Answers general questions
- ☐ Community Residents, Property Owners, Business Owners
 - Receives project details
 - Asks productive questions
 - Provides practical comments



Instructions for Applicants


Applicants shall coordinate the scheduling of meetings with Town staff prior to sending notifications. The applicant will select an electronic meeting platform (Zoom, Microsoft Teams, WebEx, GoToWebinar, etc.) which is accessible to and intuitive for the general public. The meeting shall be scheduled Tuesdays or Thursdays, between 5:00 p.m. to 7:00 p.m., and accessible during that entire window of time. The meeting cannot be held on Town observed holidays.

The following guidelines are required for the applicant to be considered in compliance. Failure to adhere to these guidelines will require the applicant to hold a new neighborhood meeting.

	Mailed Notice Requirements:
	According to UDO Section 15.3.C.1, the applicant shall send written notices of the meeting via
	first-class mail at least 10 days prior to the meeting to property owners within 200 feet of the
	proposed project. See attached template.
	The applicant will be required to include in the attached mailed notice (on applicant
	letterhead), a vicinity map which contains the existing zoning and a map of the proposed
	development and zoning.
	The attached "Project Contact Information" sheet (on applicant letterhead).
	An agenda for the meeting shall be included with the mailed notice, including an explanation
	of the process for which the meeting is being held, an explanation of next steps (possible
	revisions to the plan based on comments received, Town Council Joint Public Hearing, Land
	Use Review Board meeting, Town Council decision), and an overview of development
	proposal.
	Include these guidelines (pages 1 and 2) with the mailed notices to property owners.
_	Submittal Document Requirements:
	The attached "Summary of Electronic Neighborhood Meeting Discussion" sheet filled out,
	consisting of questions or concerns by attendees, responses from the applicant, any questions
	or concerns received prior to the meeting, and a description of how the applicant proposes to
	respond to neighborhood concerns or changes made as a result of the meeting.
	The attached "Electronic Neighborhood Meeting Attendance" sheet.
	The attached "Affidavit of Conducting an Electronic Neighborhood Meeting and
	Issues/Responses Submittal".
	All the above items listed under "Mailed Notice Requirements" sent to applicable property
	owners.
	Additional requirements:
	Auditional requirements.

☐ Should any attendee request follow up information, the applicant will be required to maintain

communication and inform town staff.

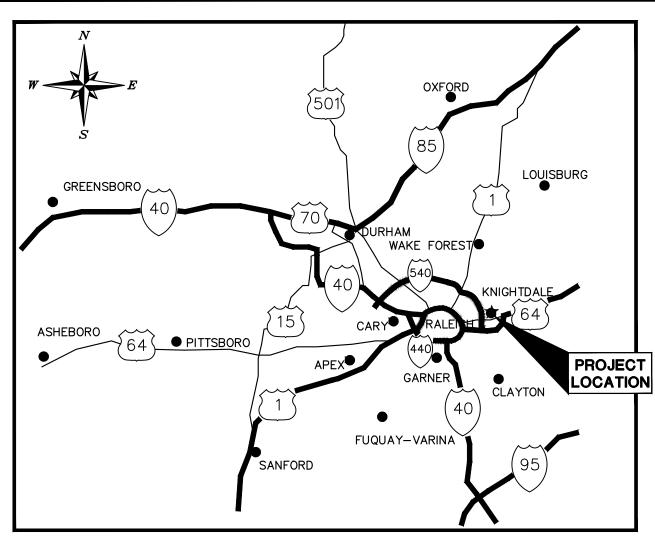

PROJECT LOCATION

MASTER PLAN SUBMITTAL FOR:

EP MART #10

7604 KNIGHTDALE BOULEVARD KNIGHTDALE, NC 27545 TOWN OF KNIGHTDALE PROJECT #ZMA-13-21

EXISTING SITE AREA: 2.33 AC SITE AREA AFTER DEDICATION: 2.23 AC EXISTING/PROPOSED USE: CONVENIENCE STORE WITH FUEL SALES EXISTING ZONING: HB (HIGHWAY BUSINESS) PROPOSED ZONING: HBCU (HIGHWAY BUSINESS CONDITIONAL USE) PARKING REQUIRED

MAXIMUM: 3.5 PER KSF GFA = 3.5 * 6.6 KSF = 23 SPACES

MINIMUM: 1/2 OF MAXIMUM = 12 SPACES ELECTRIC VEHICLE: 6 SPACES
BICYCLE SPACES: 2 IMPERVIOUS AREA CALCULATIONS PRE-DEVELOPMENT: 71,900 SF (1.65 AC) POST-DEVELOPMENT: 61,800 SF (1.42 AC) IMPERVIOUS AREA IS REDUCED THEREFORE NO STORM WATER TREATMENT IS REQUIRED.

Sheet L	ist Table
Sheet Number	Sheet Title
C0.0	COVER SHEET
C1.0	EXISTING CONDITIONS
C1.1	DEMOLITION PLAN
C2.0	SITE PLAN
C3.0	GRADING AND DRAINAGE PLAN
C4.0	UTILITY PLAN
C5.0	ARCHITECTURAL ELEVATIONS
C5.1	ARCHITECTURAL ELEVATIONS
C5.2	ARCHITECTURAL ELEVATIONS
C5.3	ARCHITECTURAL ELEVATIONS
C5.4	ARCHITECTURAL ELEVATIONS
C5.5	ARCHITECTURAL ELEVATIONS
L1.0	LANDSCAPE PLAN
I1.0	LIGHTING PLAN
I1.1	LIGHTING DETAILS
I1.2	LIGHTING DETAILS
I1.3	LIGHTING DETAILS

ALL CONSTRUCTION TO BE IN ACCORDANCE WITH ALL TOWN OF KNIGHTDALE AND/OR NCDOT STANDARDS AND SPECIFICATIONS.

WATER ALLOCATION: EXISTING WATER CUSTOMER.

EASTERN PETROLEUM CORP. SITE DEVELOPER: dba EP MART PO BOX 398

ENFIELD, NC 27823 PHONE: (252) 445.6606 ATTN: YVONNE JONES

PROJECT OWNER AND CONSULTANT

CIVIL ENGINEER:

KIMLEY-HORN AND ASSOCIATES, INC. 421 FAYETTEVILLE ST., SUITE 600 RALEIGH, NORTH CAROLINA 27601 PHONE: (919) 653-2927 ATTN.: CHRIS BOSTIC, P.E. chris.bostic@kimley-horn.com

LANDSCAPE ARCHITECT:

KIMLEY-HORN AND ASSOCIATES, INC. 421 FAYETTEVILLE ST., SUITE 600 RALEIGH, NORTH CAROLINA 27601 PHONE: (919) 678-4170 ATTN.: MATT GROSS, PLA matt.gross@kimley-horn.com

TIMMONS GROUP 5410 TRINITY ROAD RALEIGH, NC 27607 PHONE: (919) 779-4854 NC CERTIFICATE OF AUTHORIZATION: F-0102

PREPARED IN THE OFFICE OF: Kimley» Horn

421 FAYETTEVILLE STREET - SUITE 600 - RALEIGH, NORTH CAROLINA 27601 PHONE: (919) 677-2000

PRELIMINARY NOT FOR CONSTRUCTION

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VICINITY MAP

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JUNE 27, 2022

JOB NUMBER:

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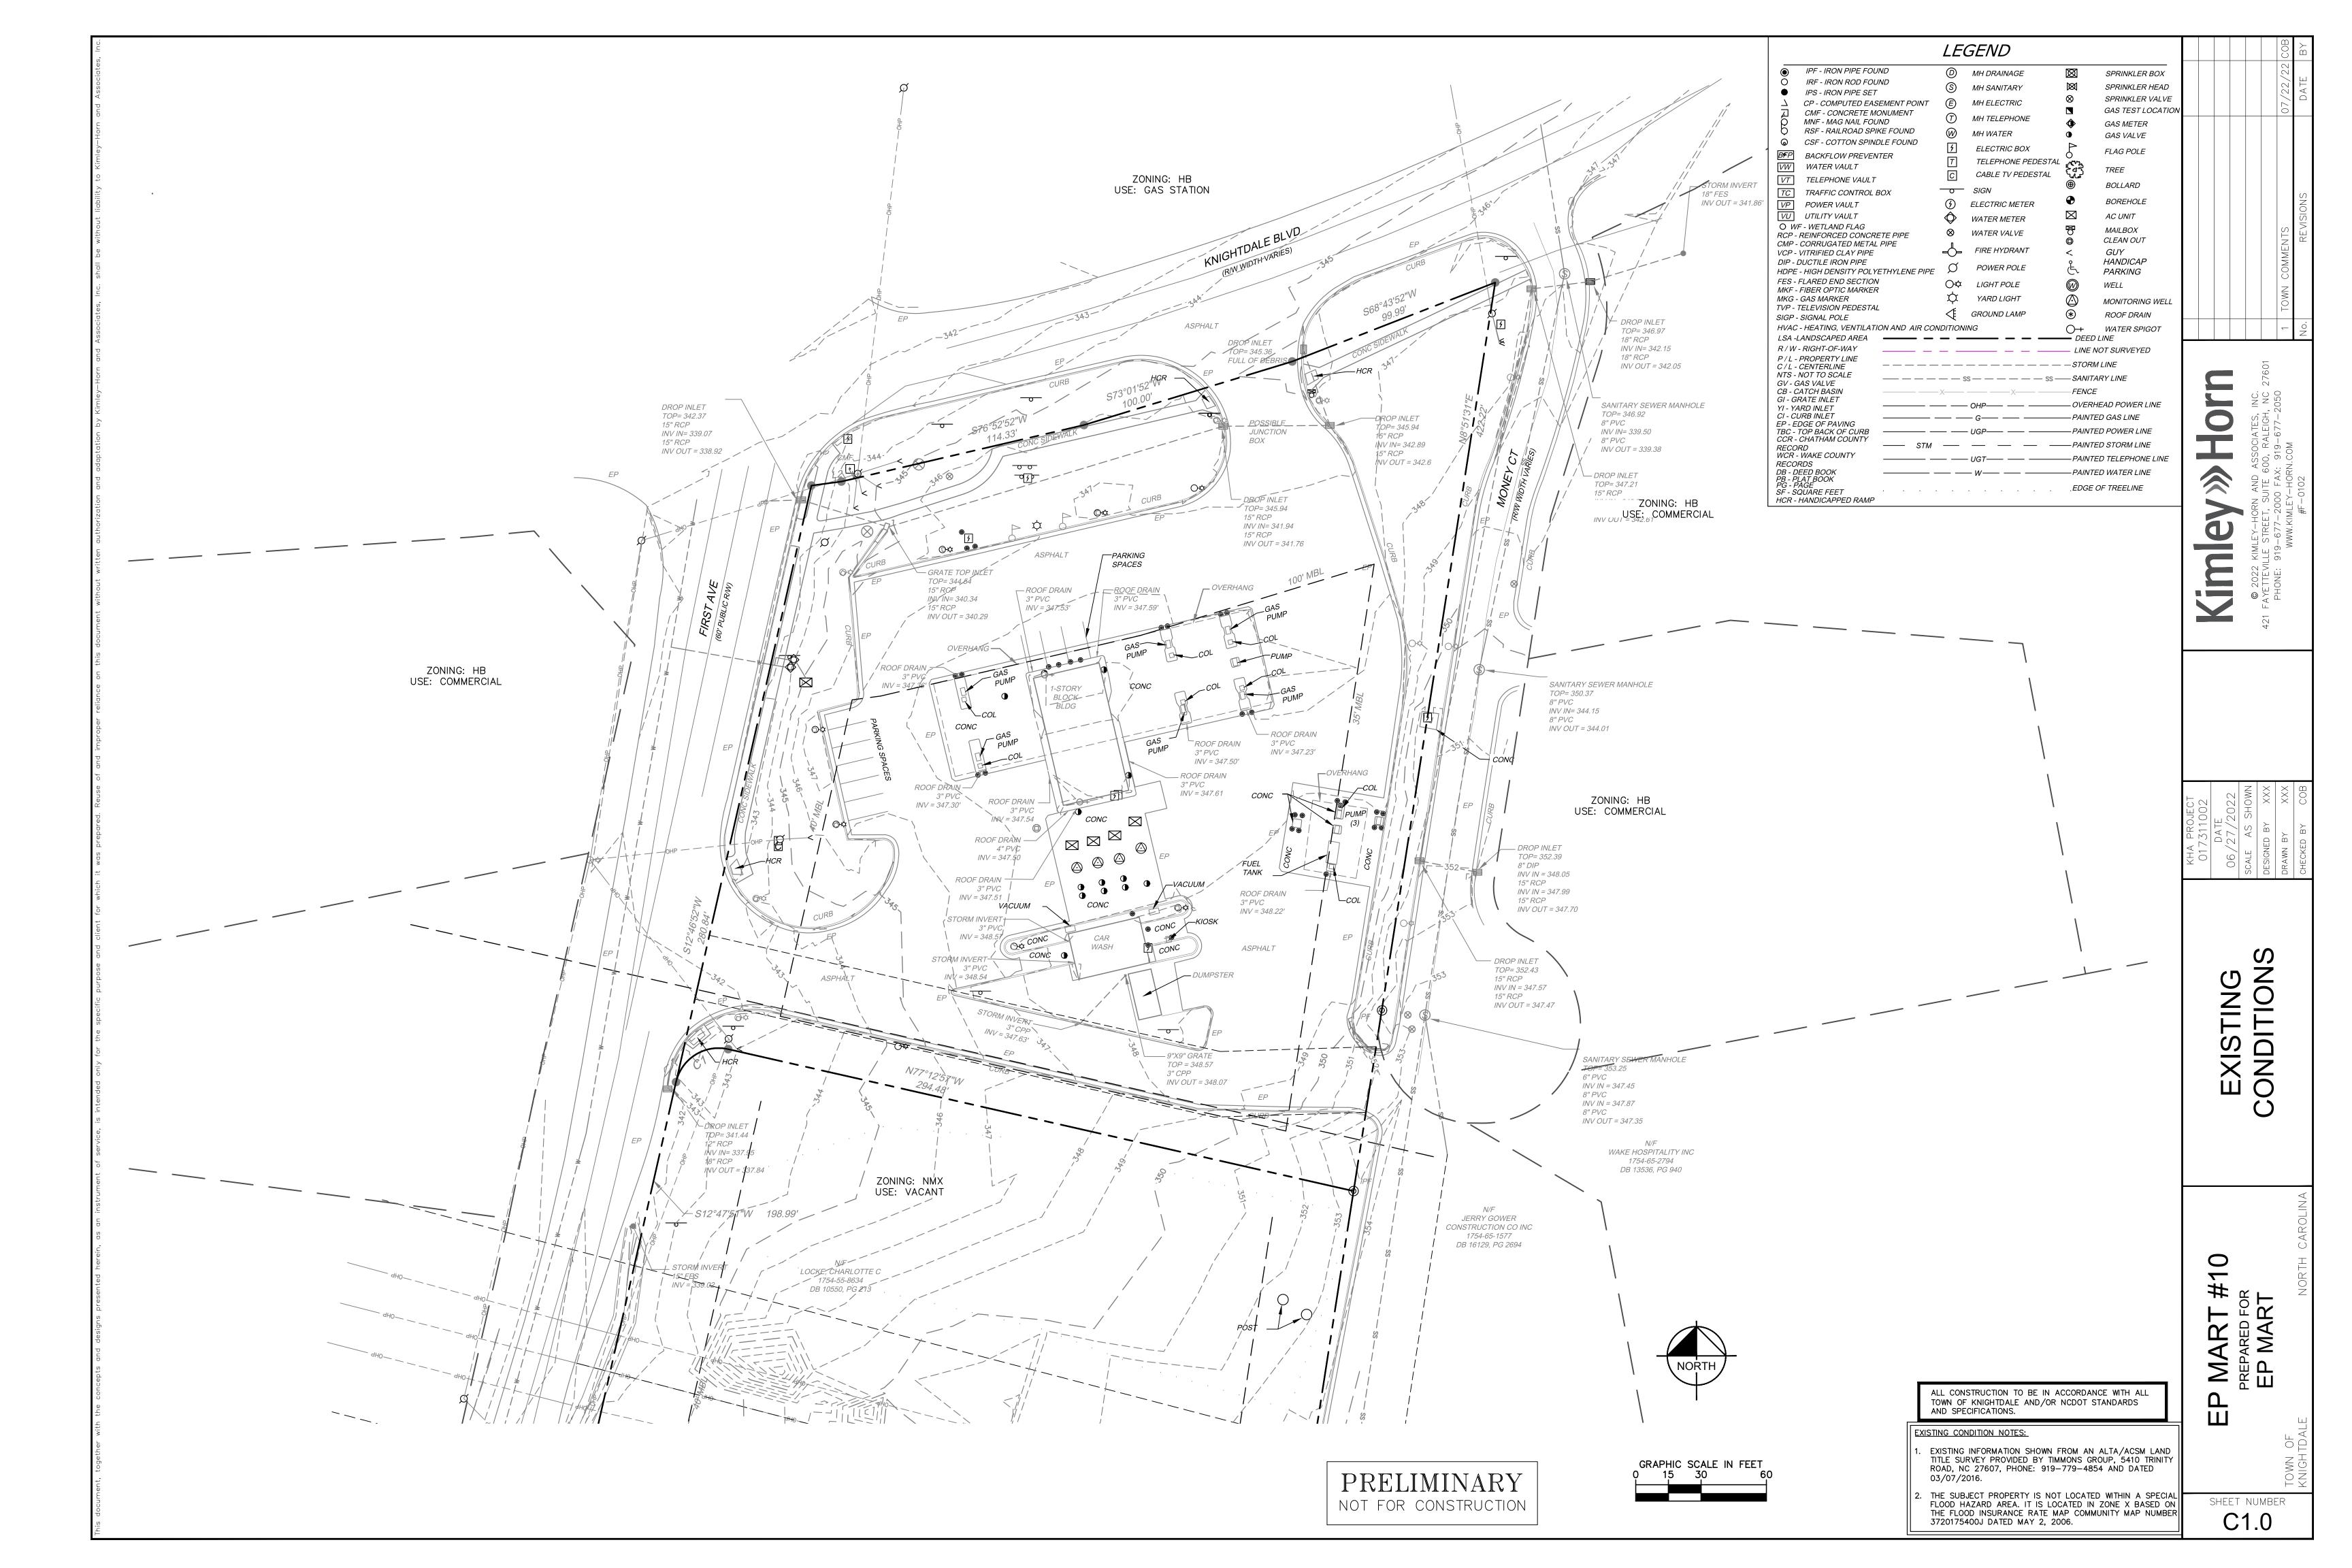
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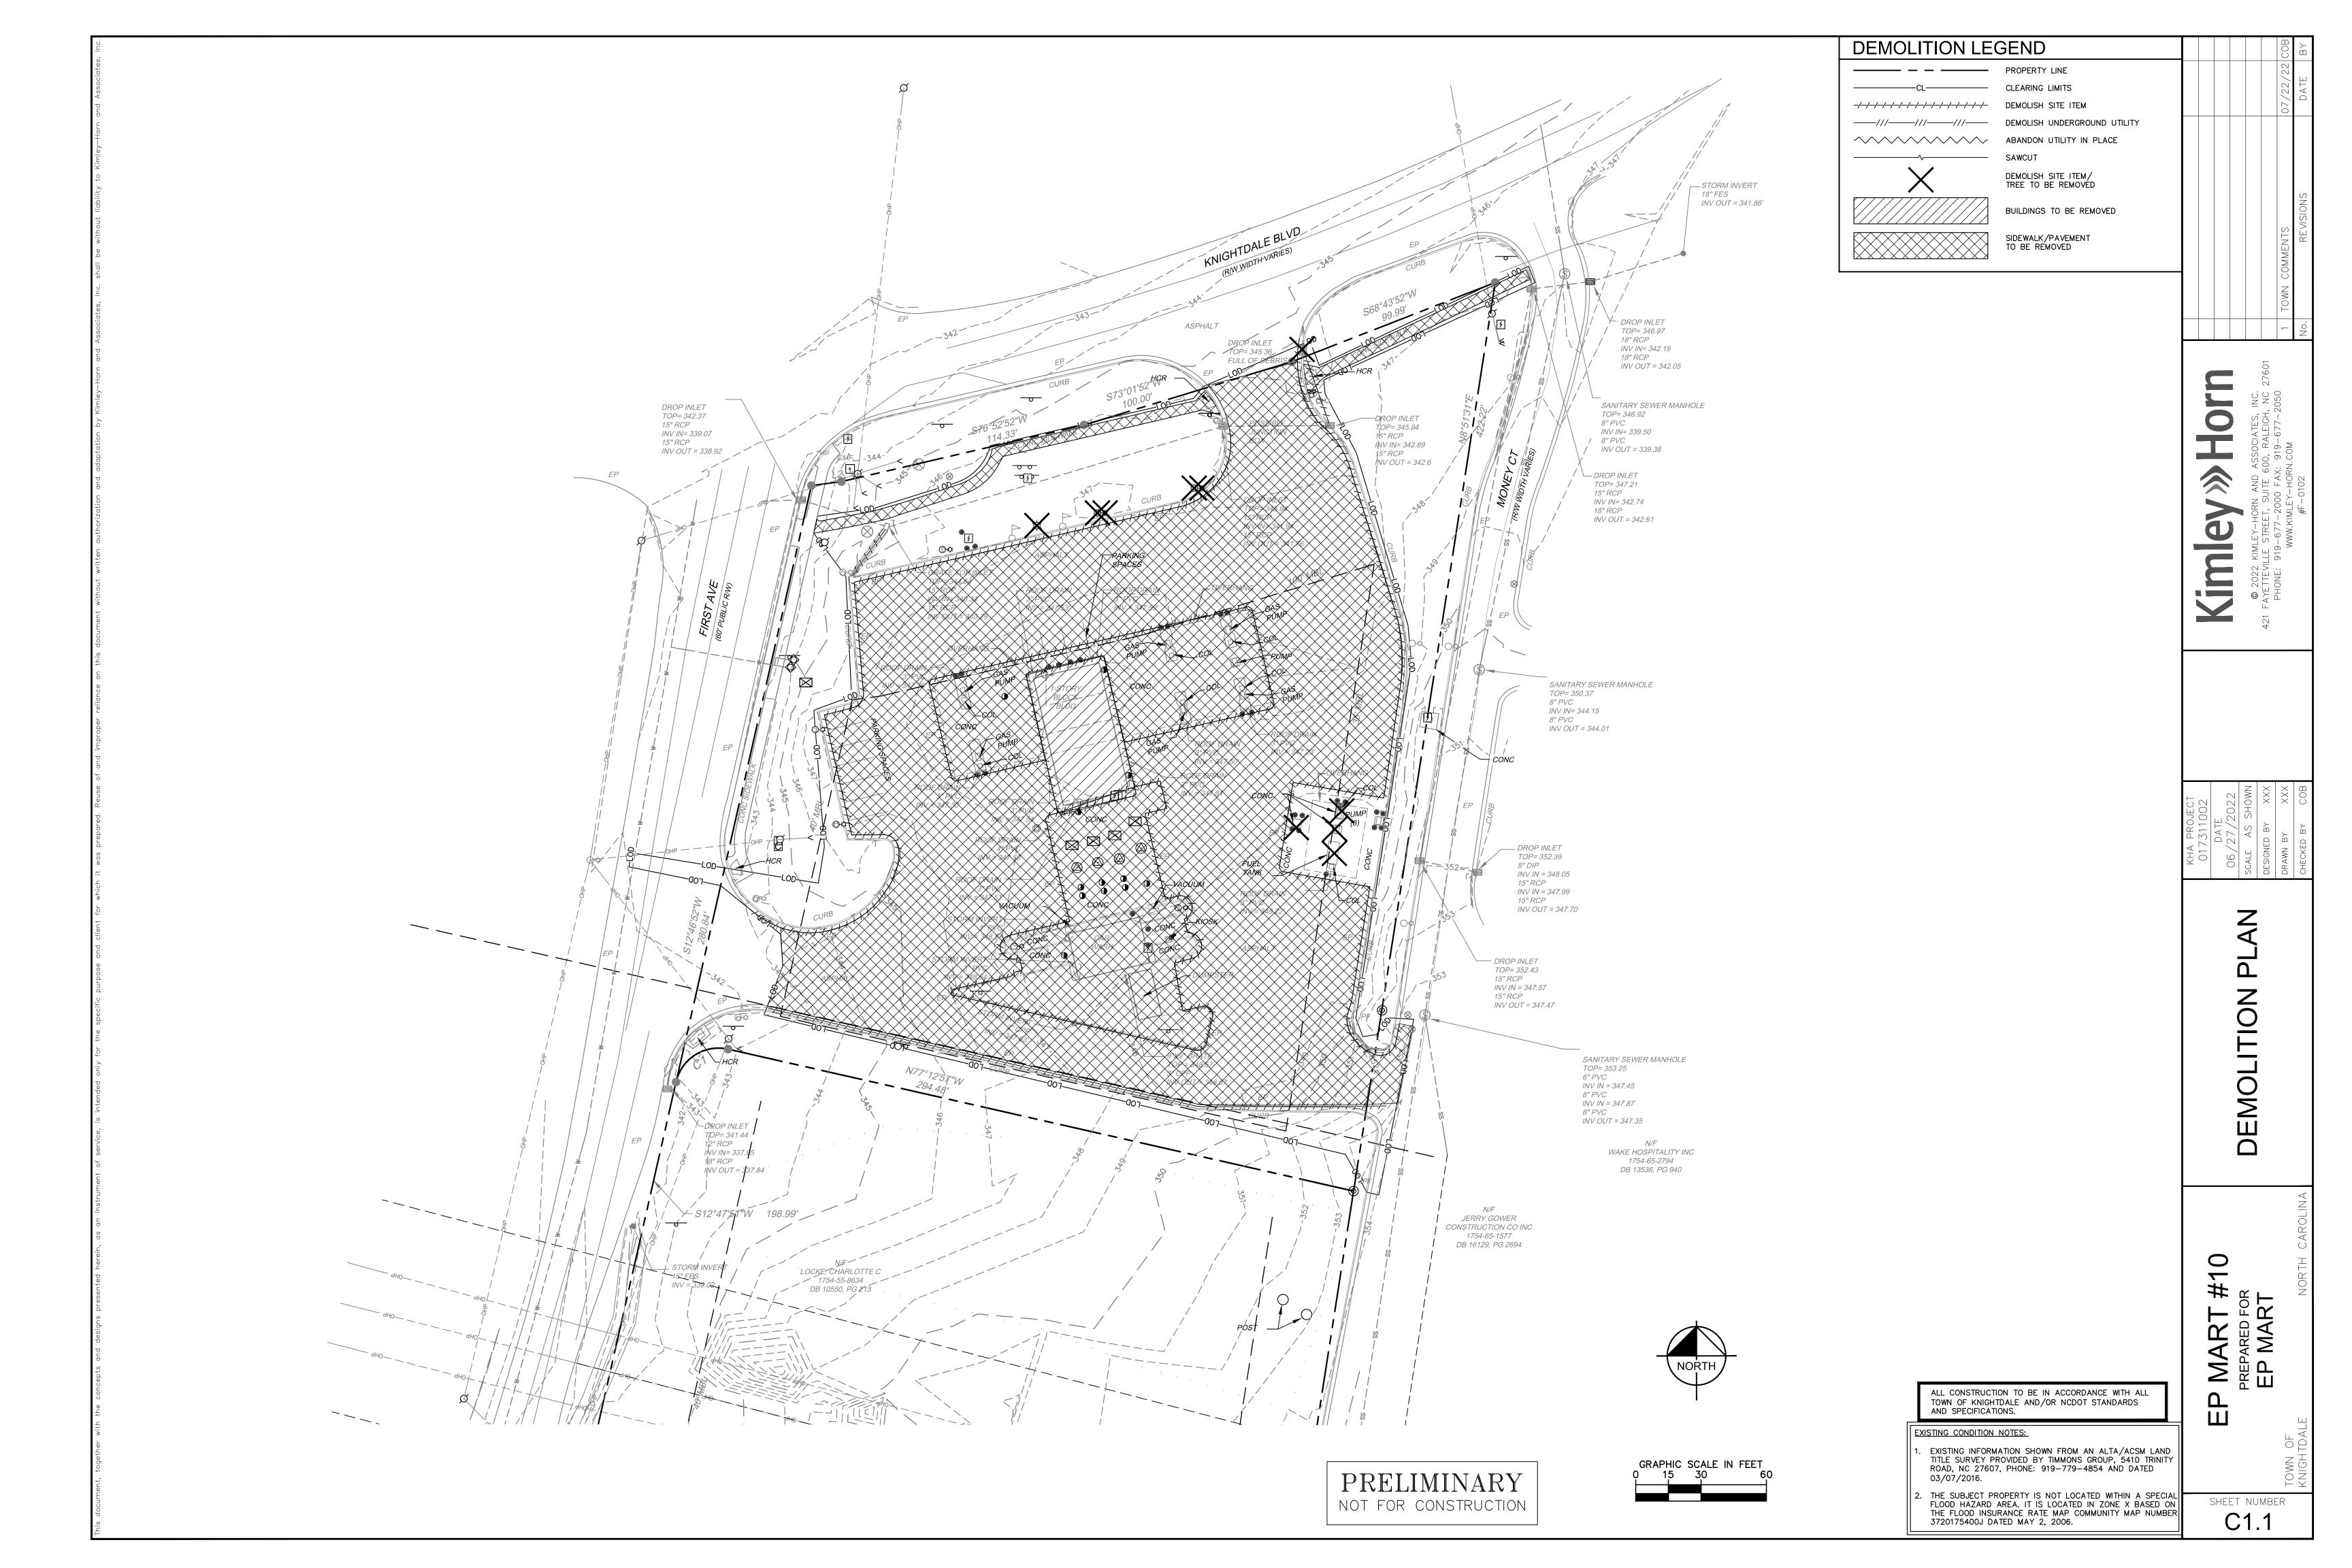
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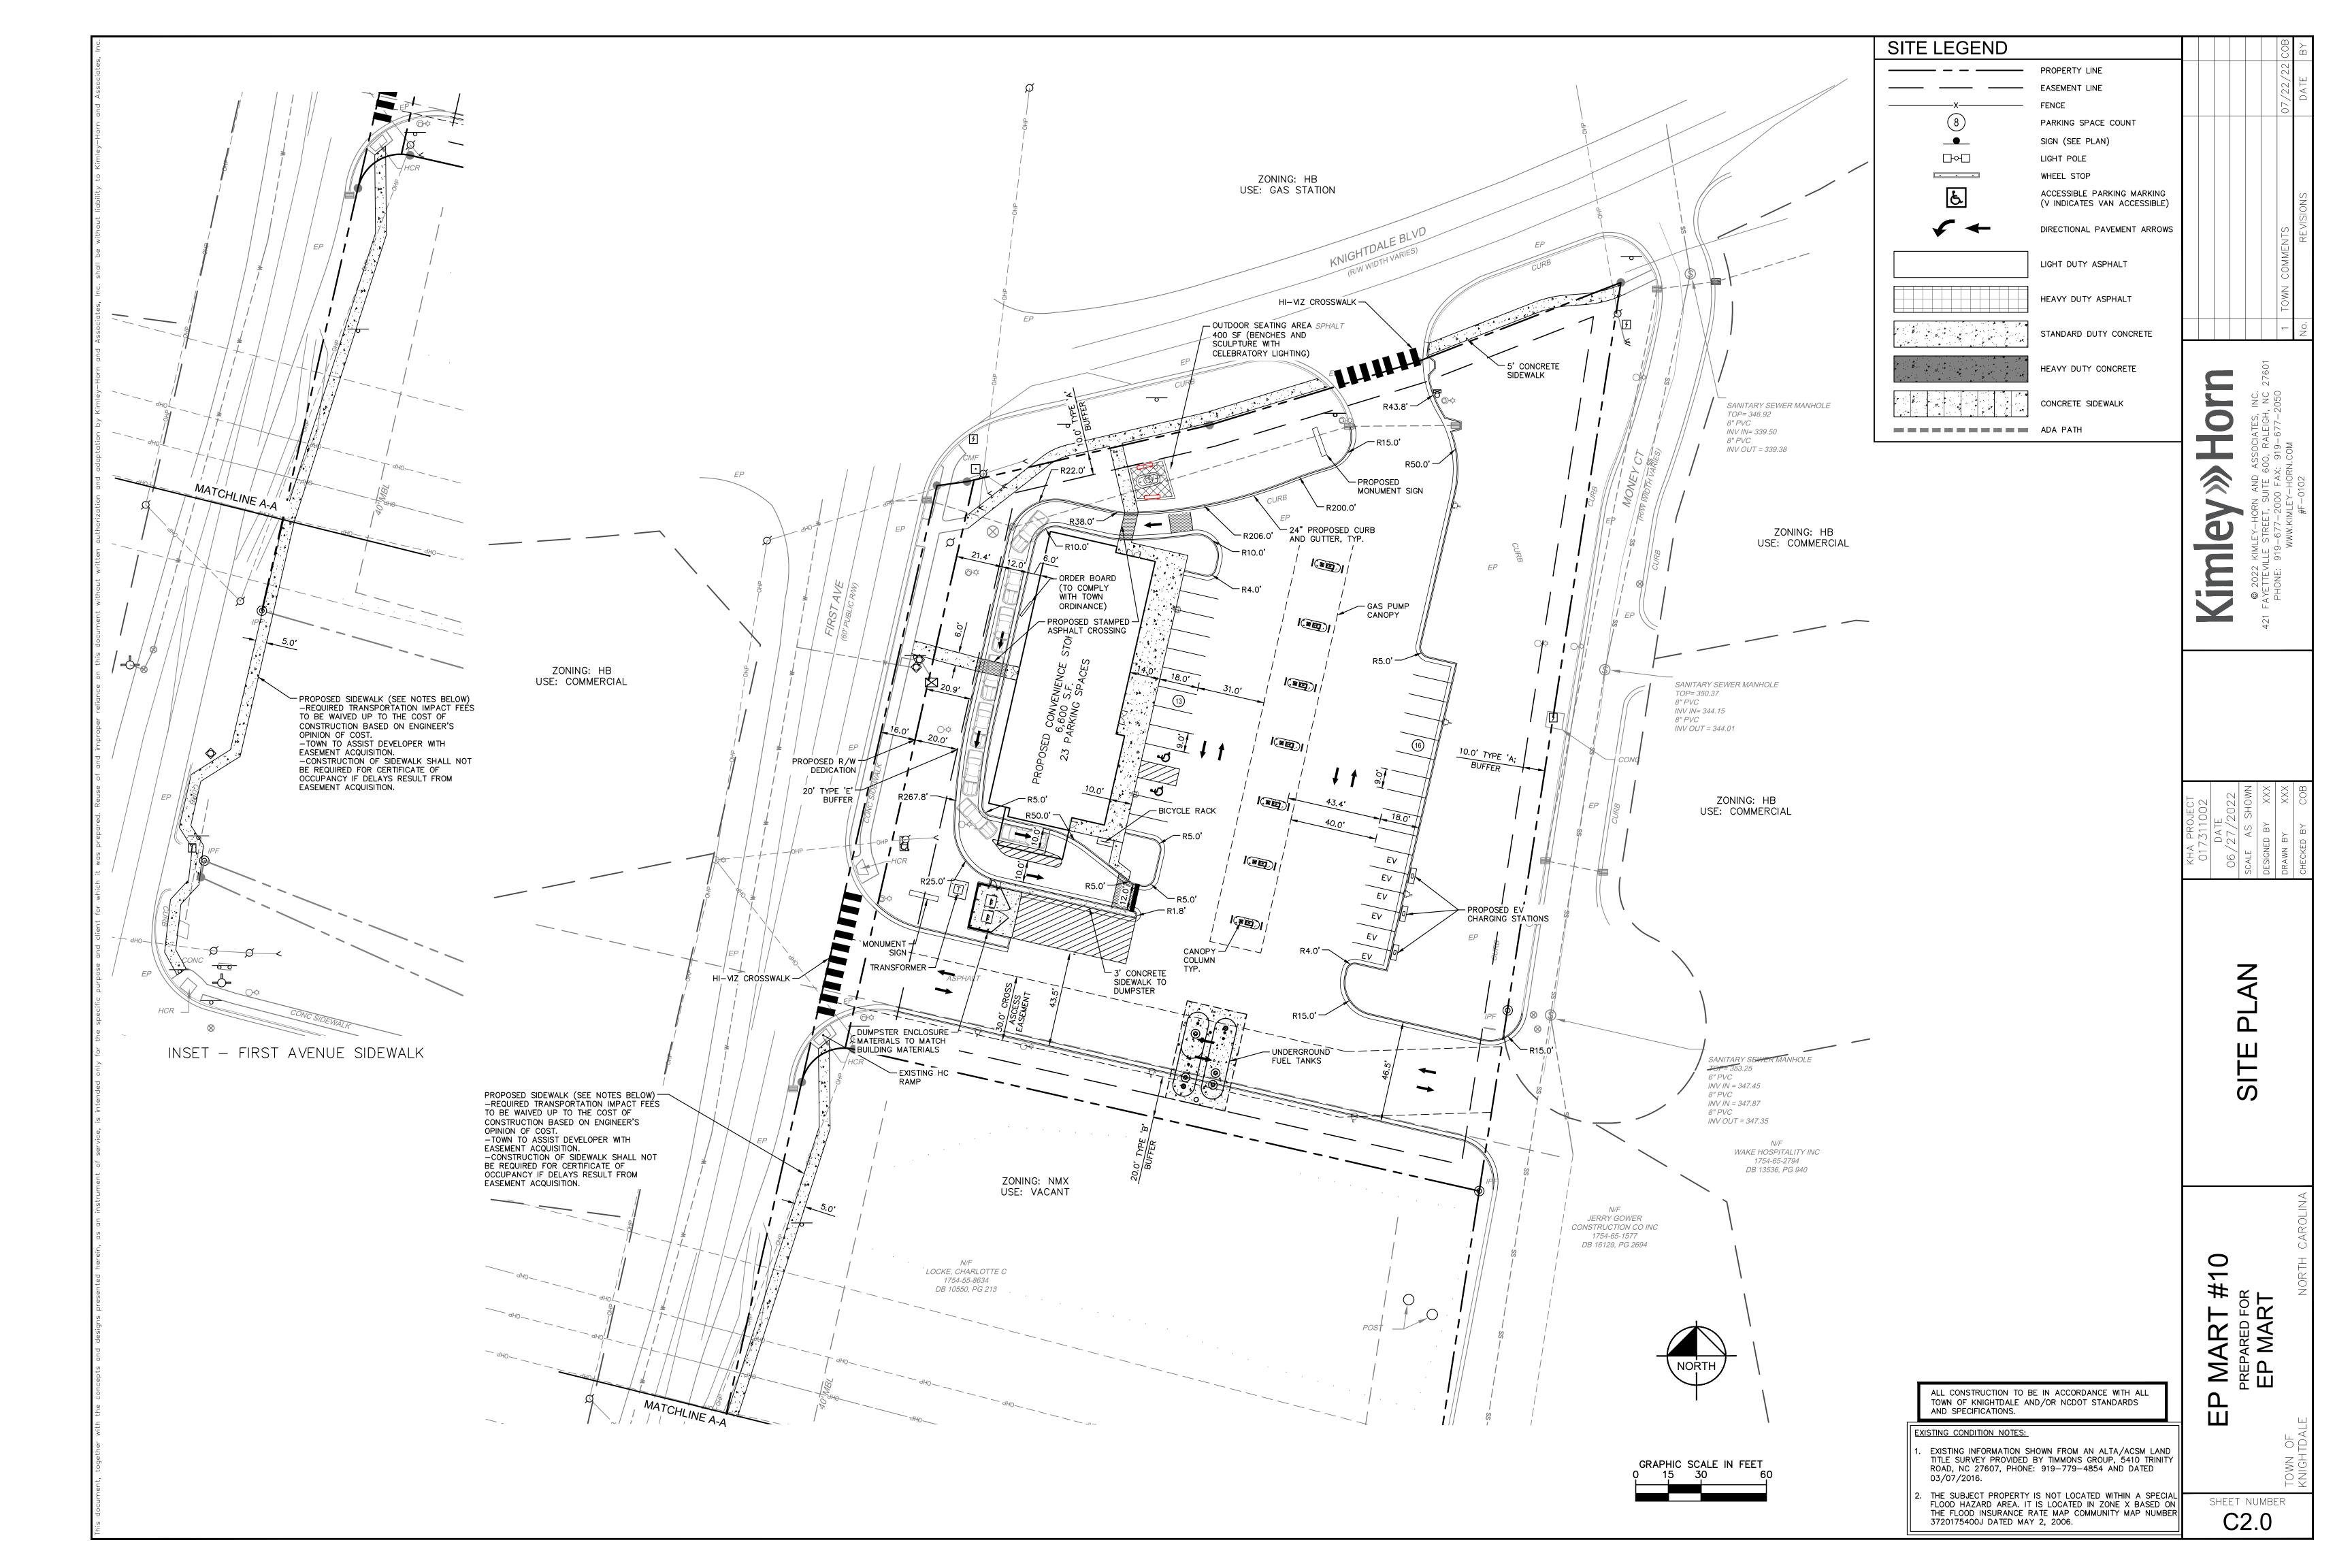
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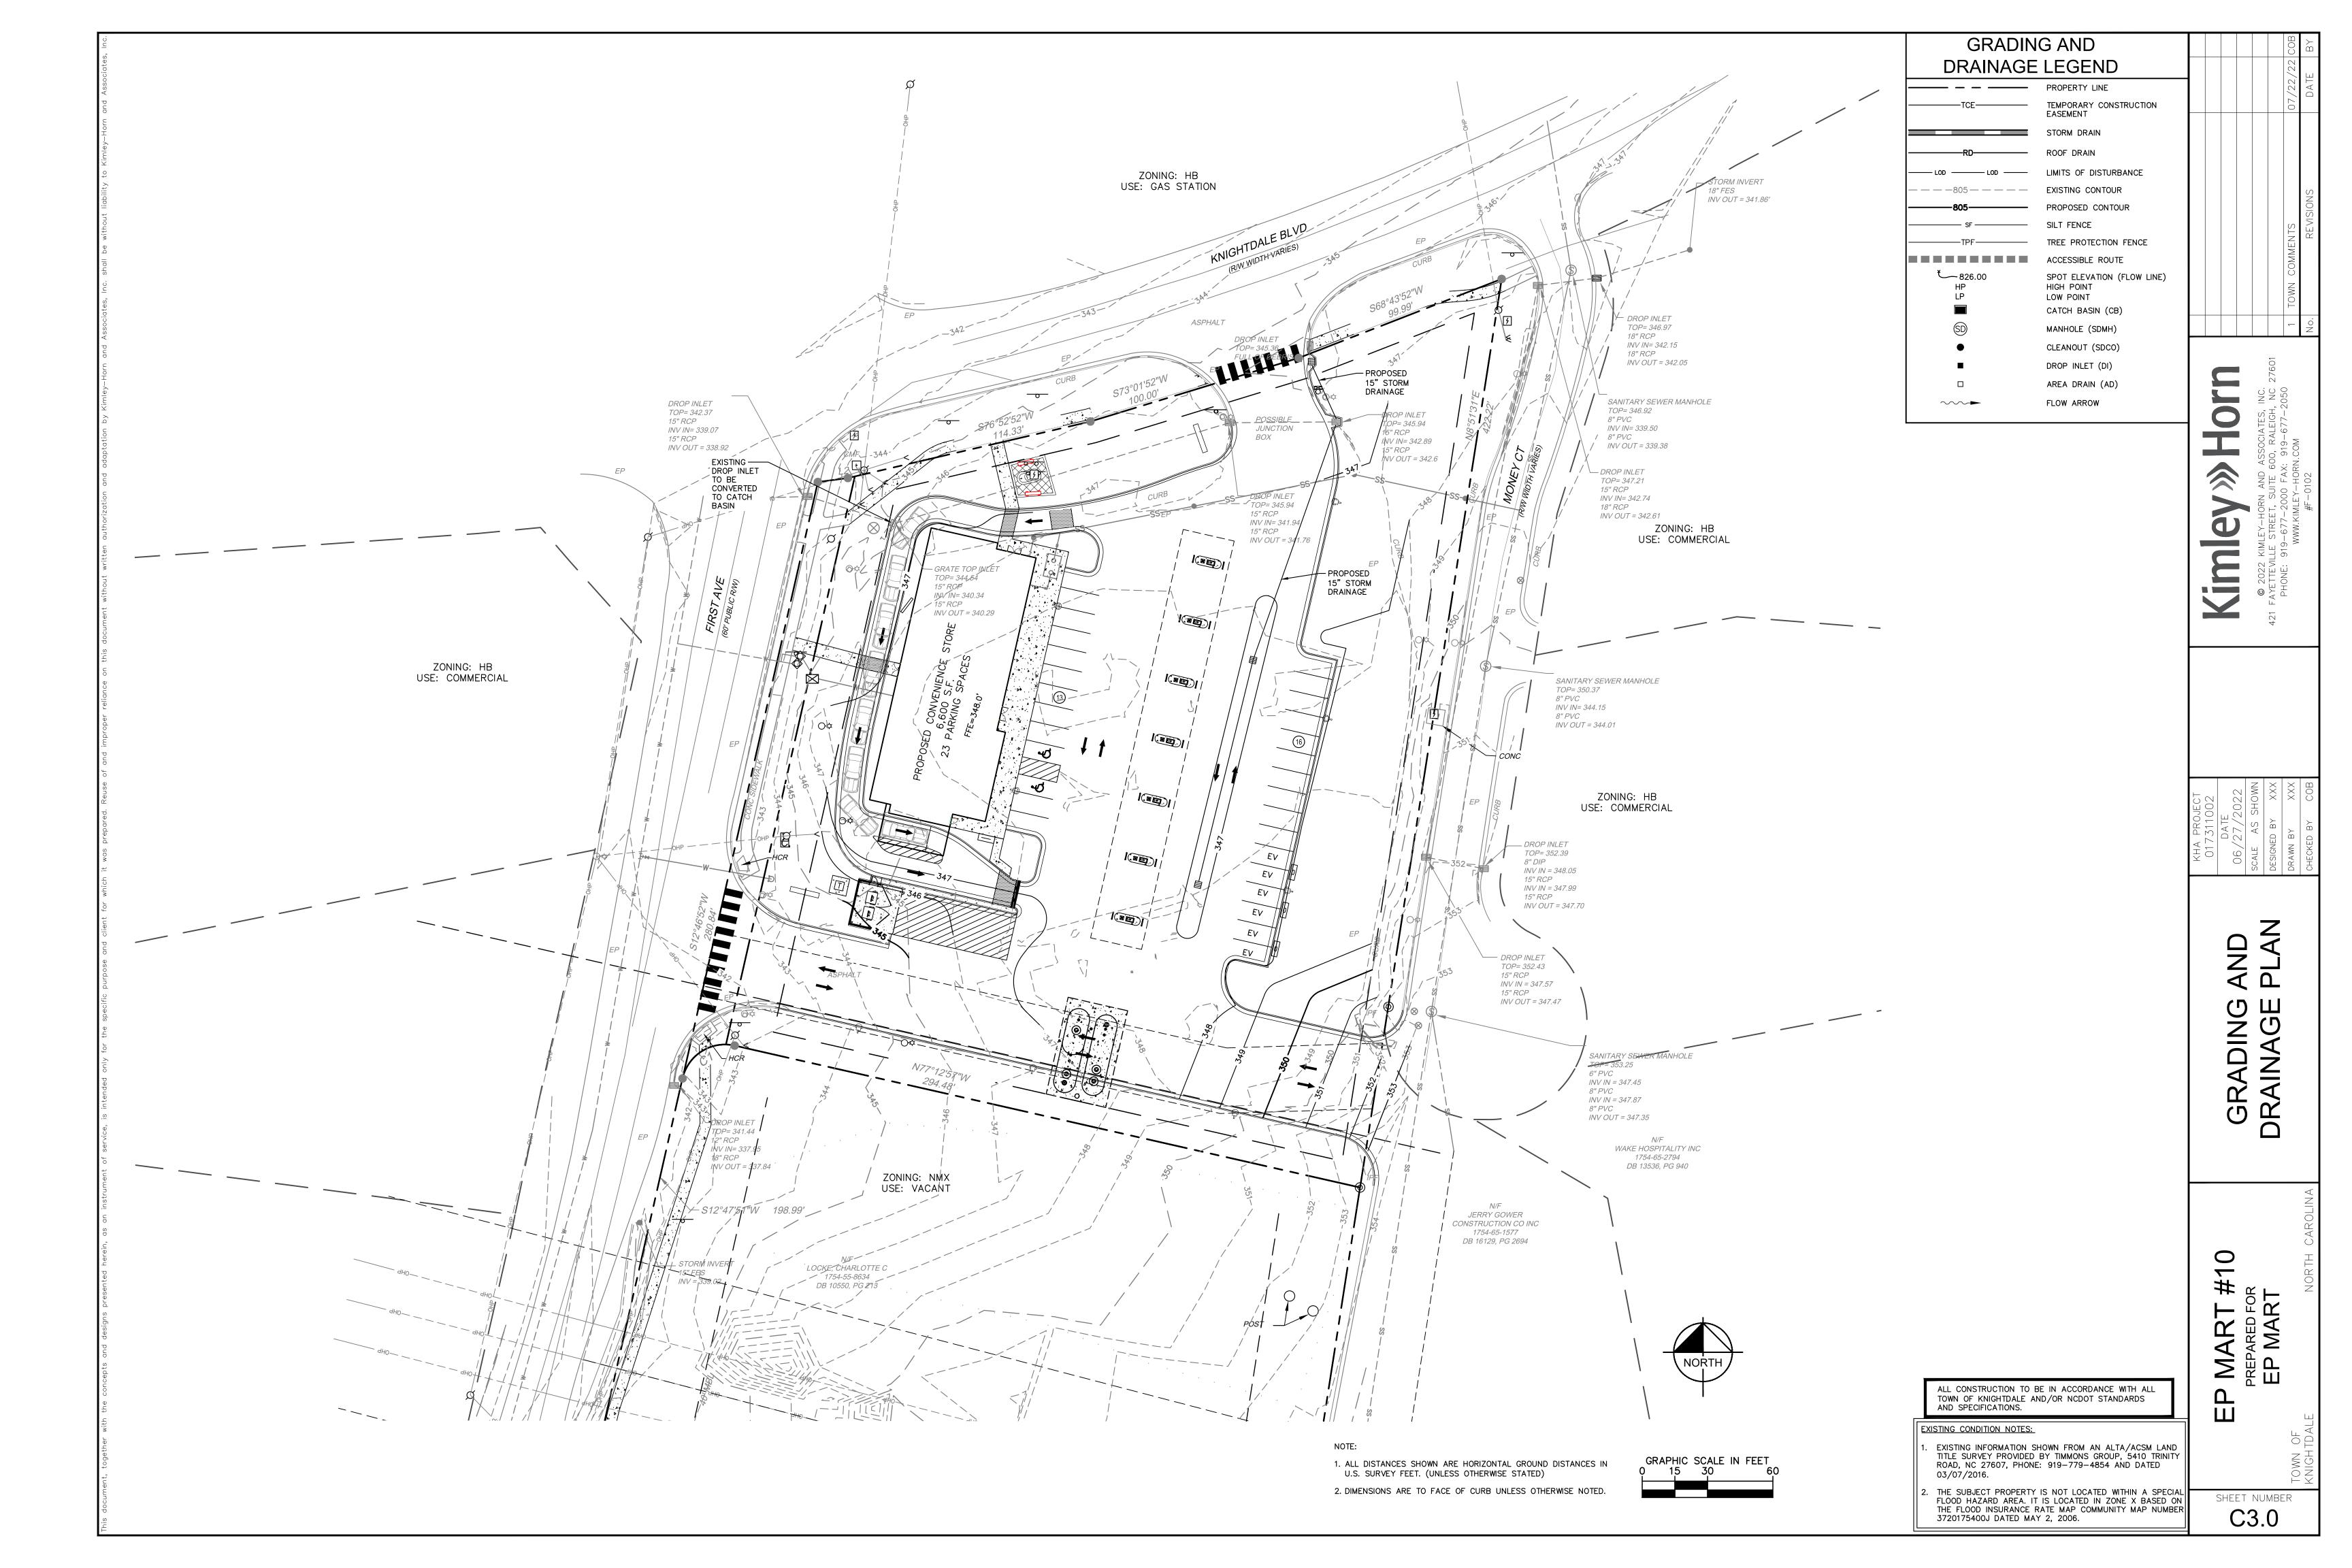
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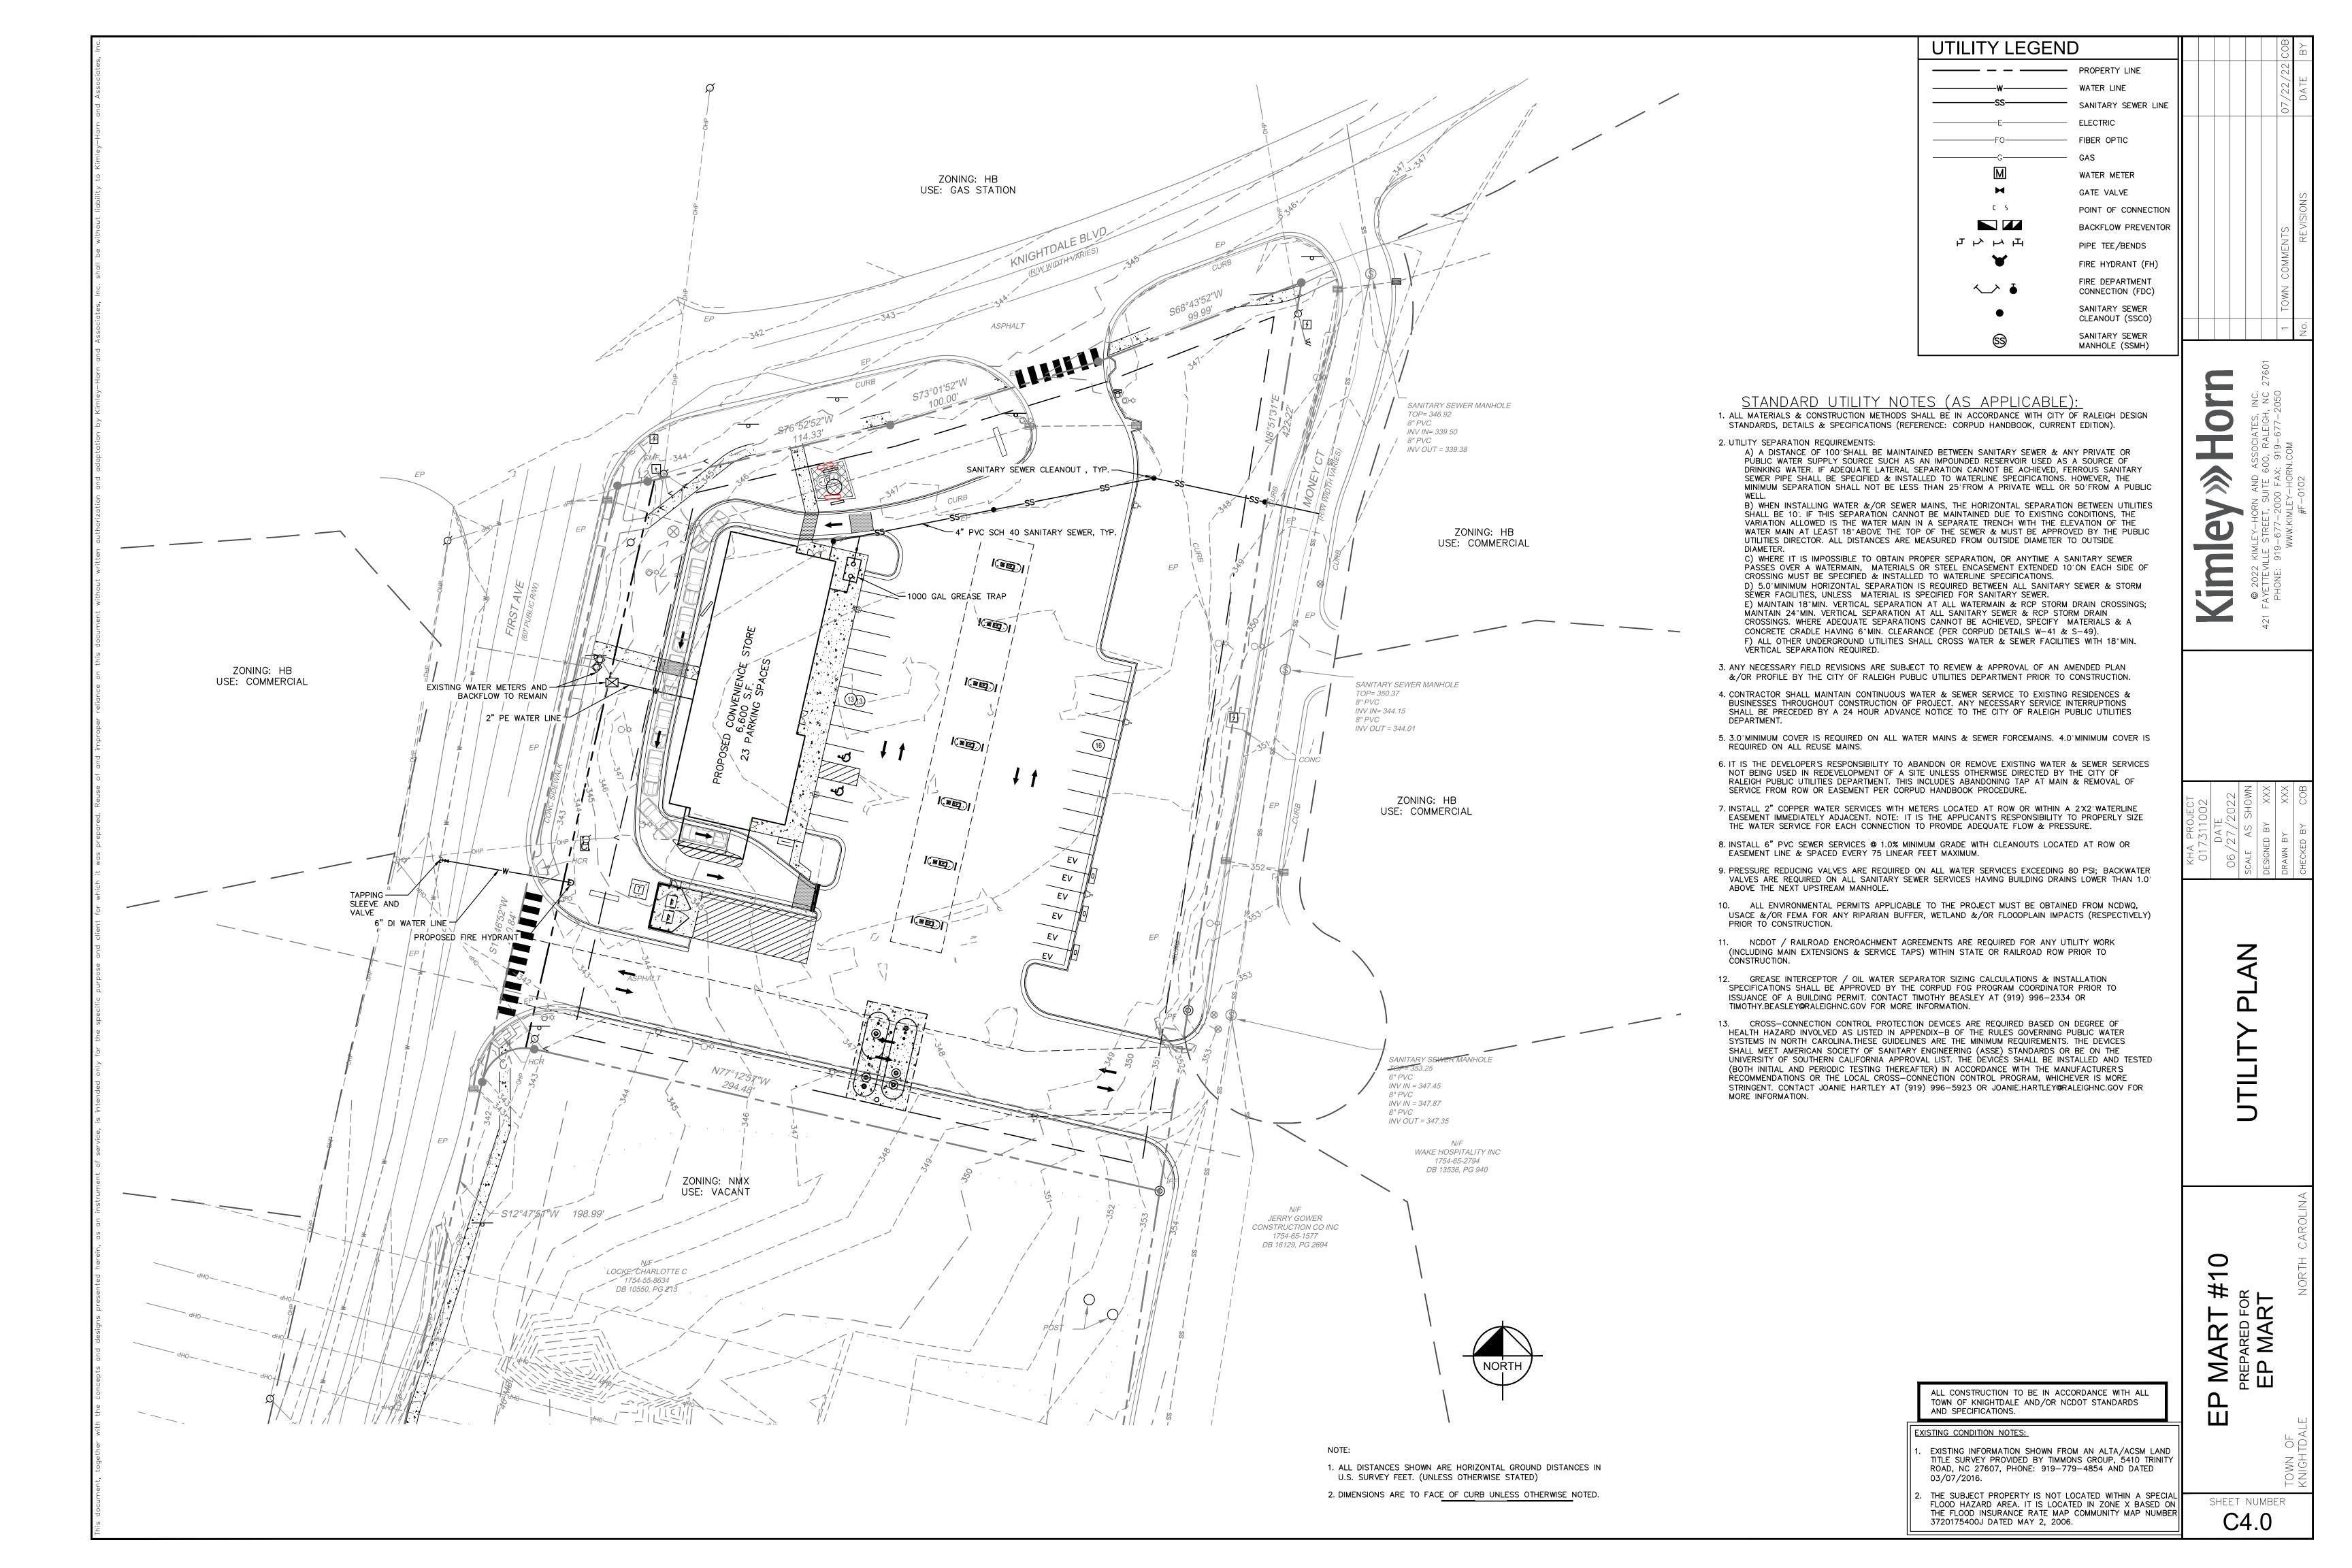
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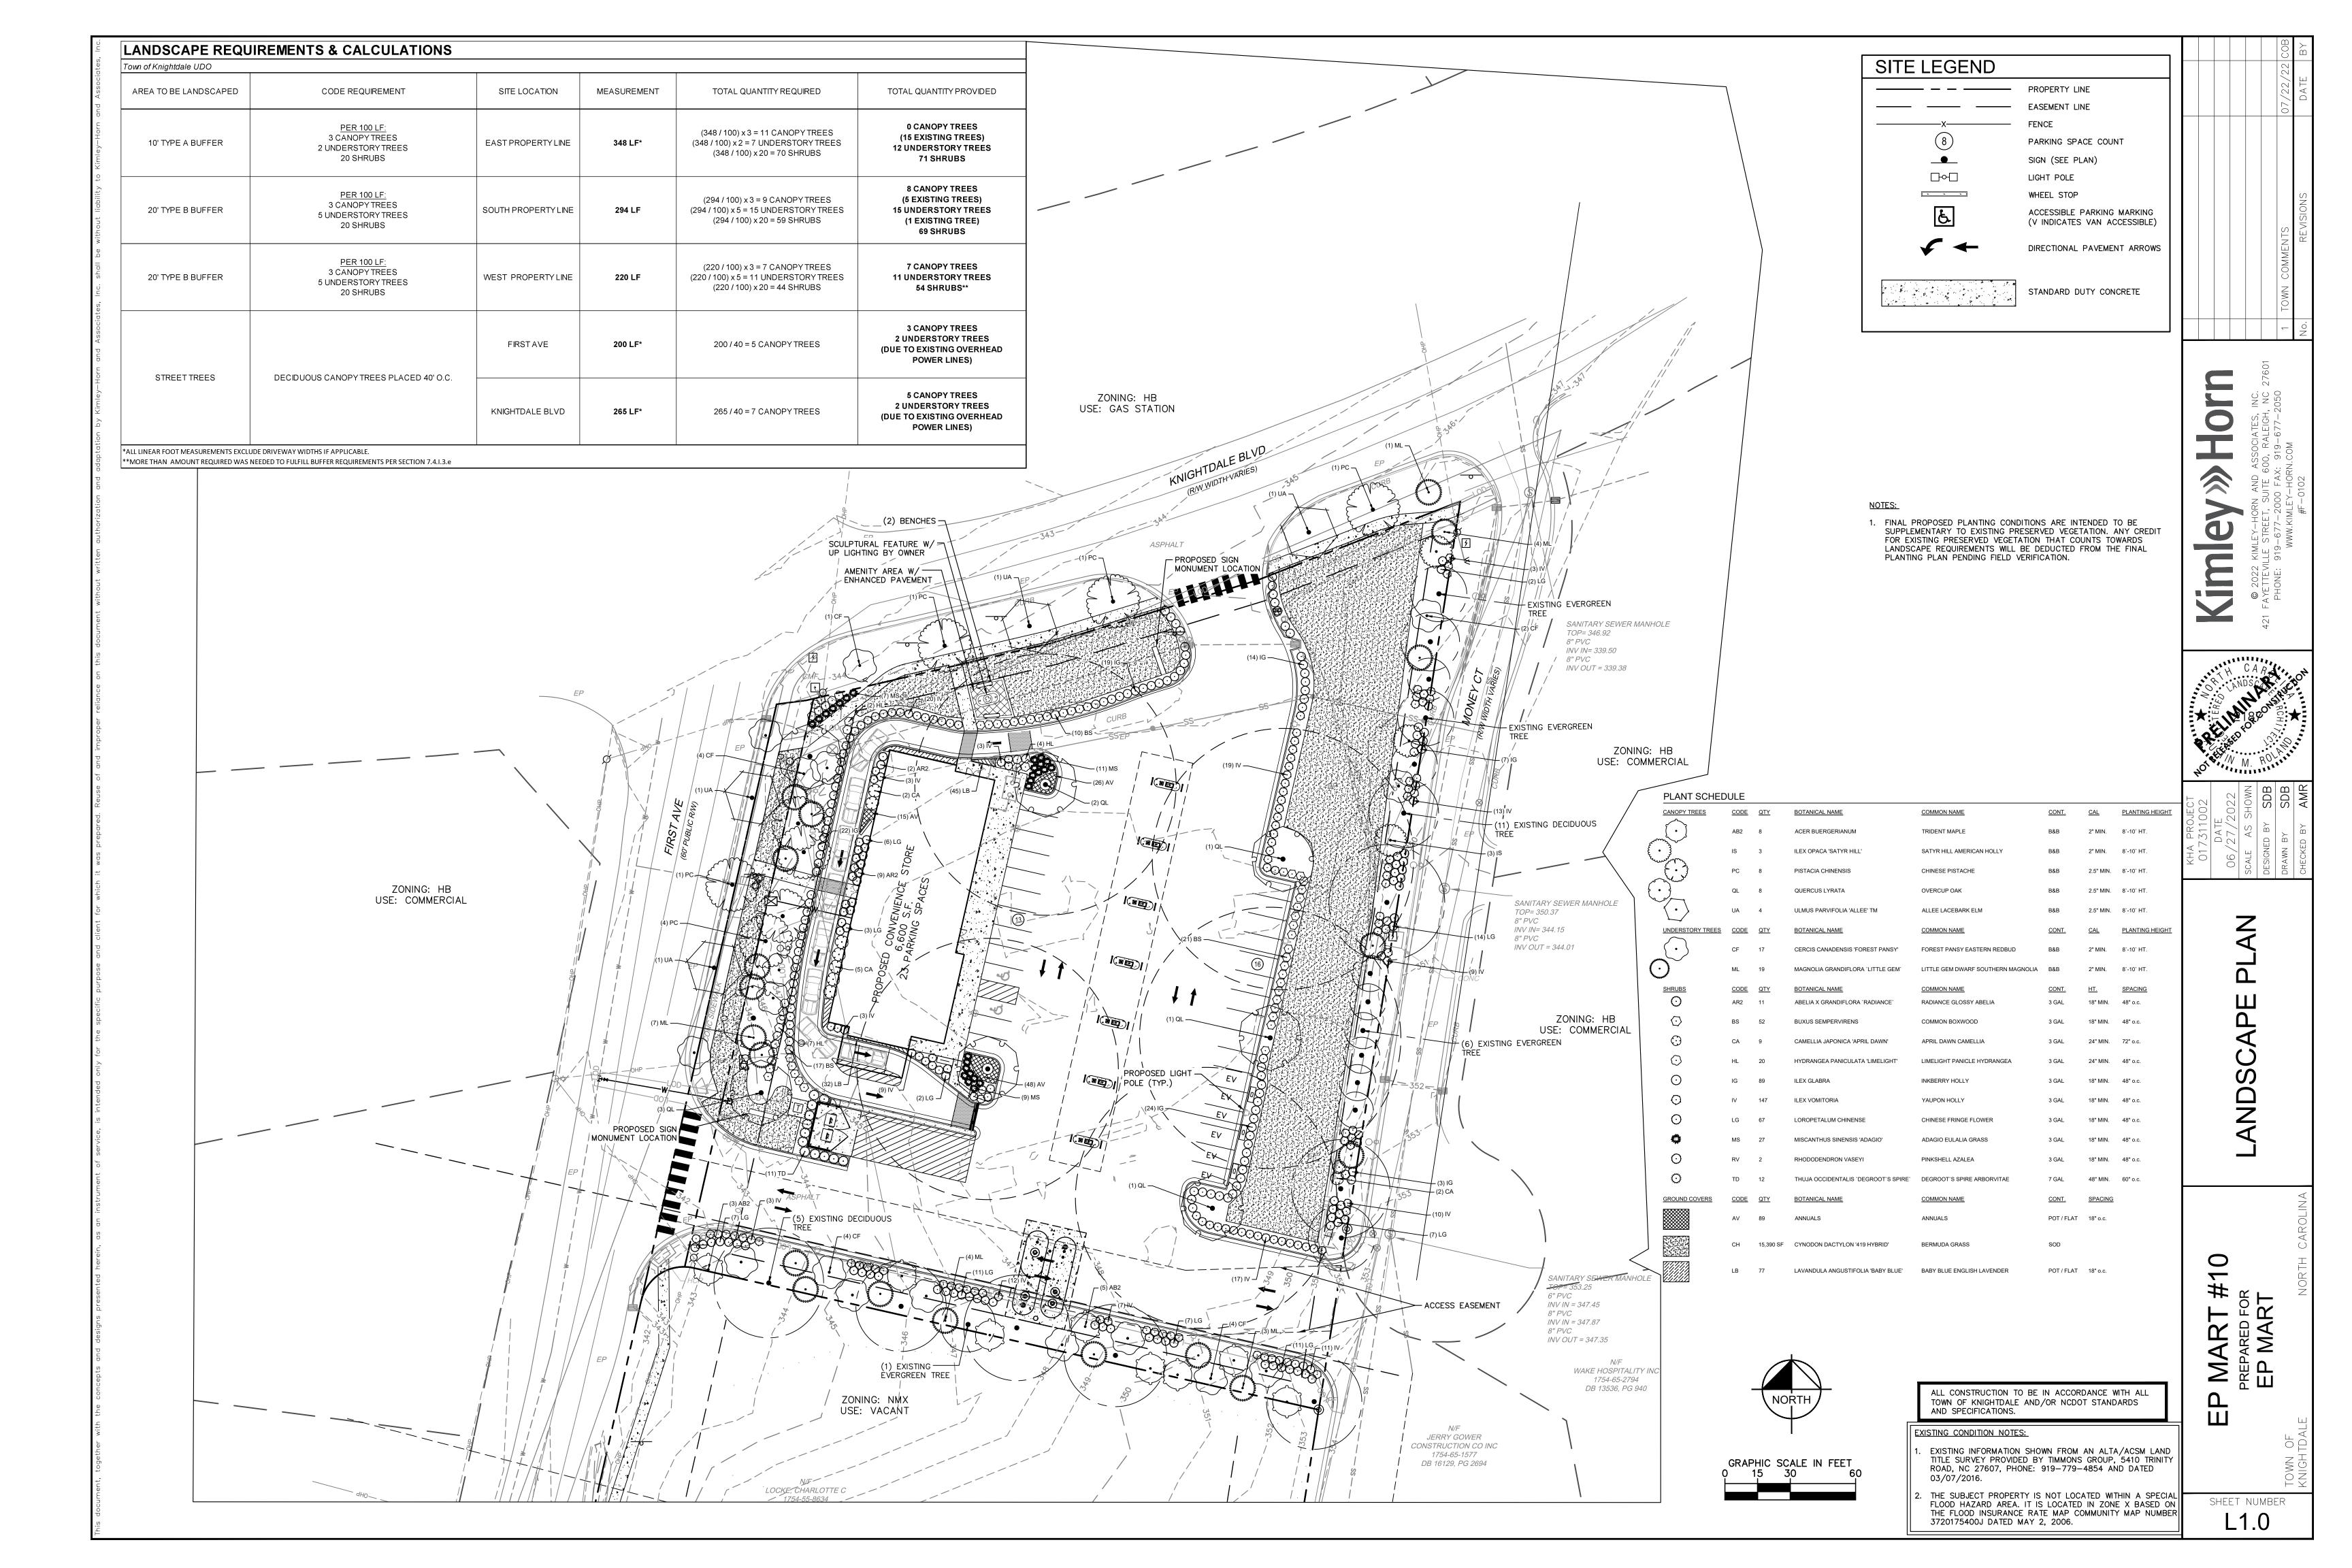













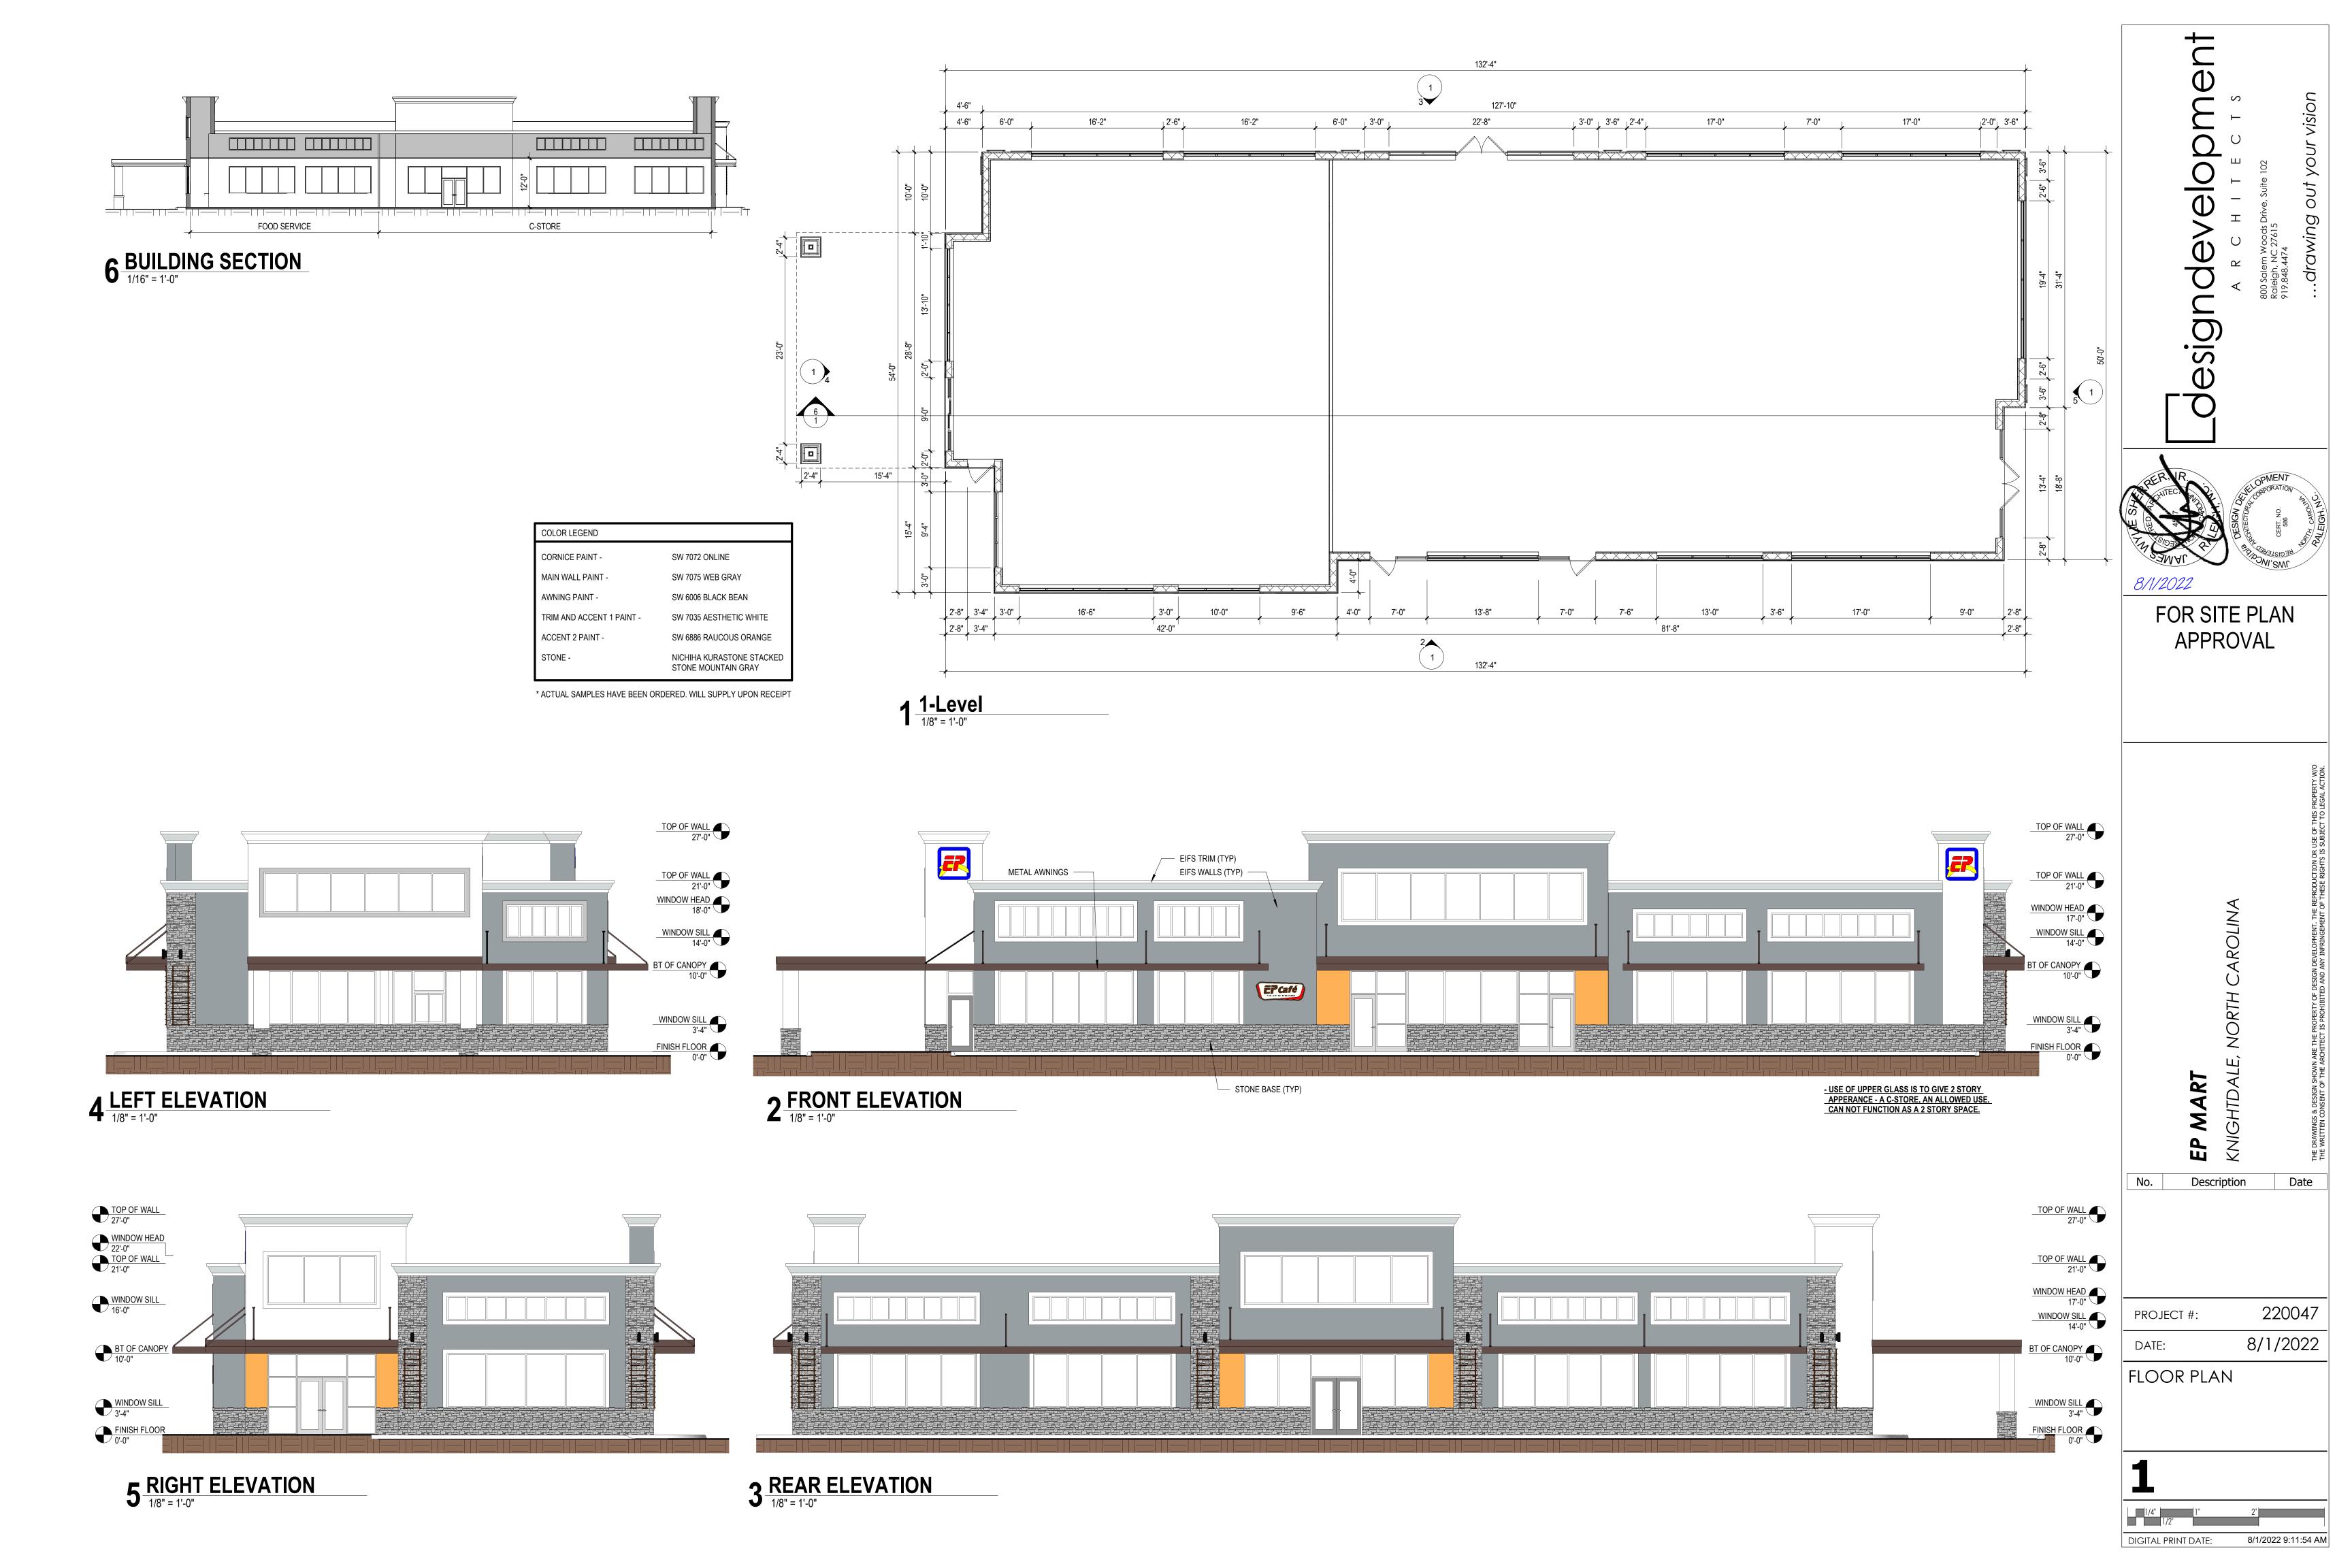



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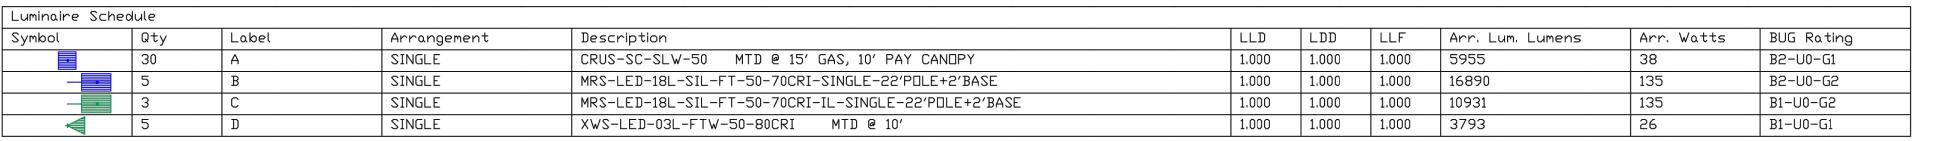


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ARCHITECTS

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LIGHTING

<u>الله</u>

SHEET NUMBER

PHOTOMETRIC EVALUATION NOT FOR CONSTRUCTION Based on the information provided, all dimensions and luminaire locations

document for ordering product.

| Calculation Summary

ALL CALC POINTS

PAY CANDPY

INSIDE CURB

CANDPY

CalcType

Illuminance

Illuminance

Illuminance

Illuminance

1.66

13.94

20.86


3.95

shown represent recommended positions. The engineer and/or architect must determine the applicability of the layout to existing or future field conditions. This lighting plan represents illumination levels calculated from laboratory data taken under controlled conditions in accordance with The Illuminating Engineering Society (IES) approved methods. Actual performance of any manufacturer's luminaires may vary due to changes in electrical voltage, tolerance in lamps/LED's and other variable field conditions. Calculations do not include obstructions such as buildings, curbs, landscaping, or any other architectural elements unless noted. Fixture nomenclature noted does not include mounting hardware or poles. This drawing is for photometric evaluation purposes only and should not be used as a construction document or as a final Total Watts = 2350 LIGHTING PROPOSAL LO-155813 EP MART
KNIGHTDALE BLVD & FIRST AVE
KNIGHTDALE,NC

Total Project Watts

SCALE: 1"=30'

22.9 N.A.

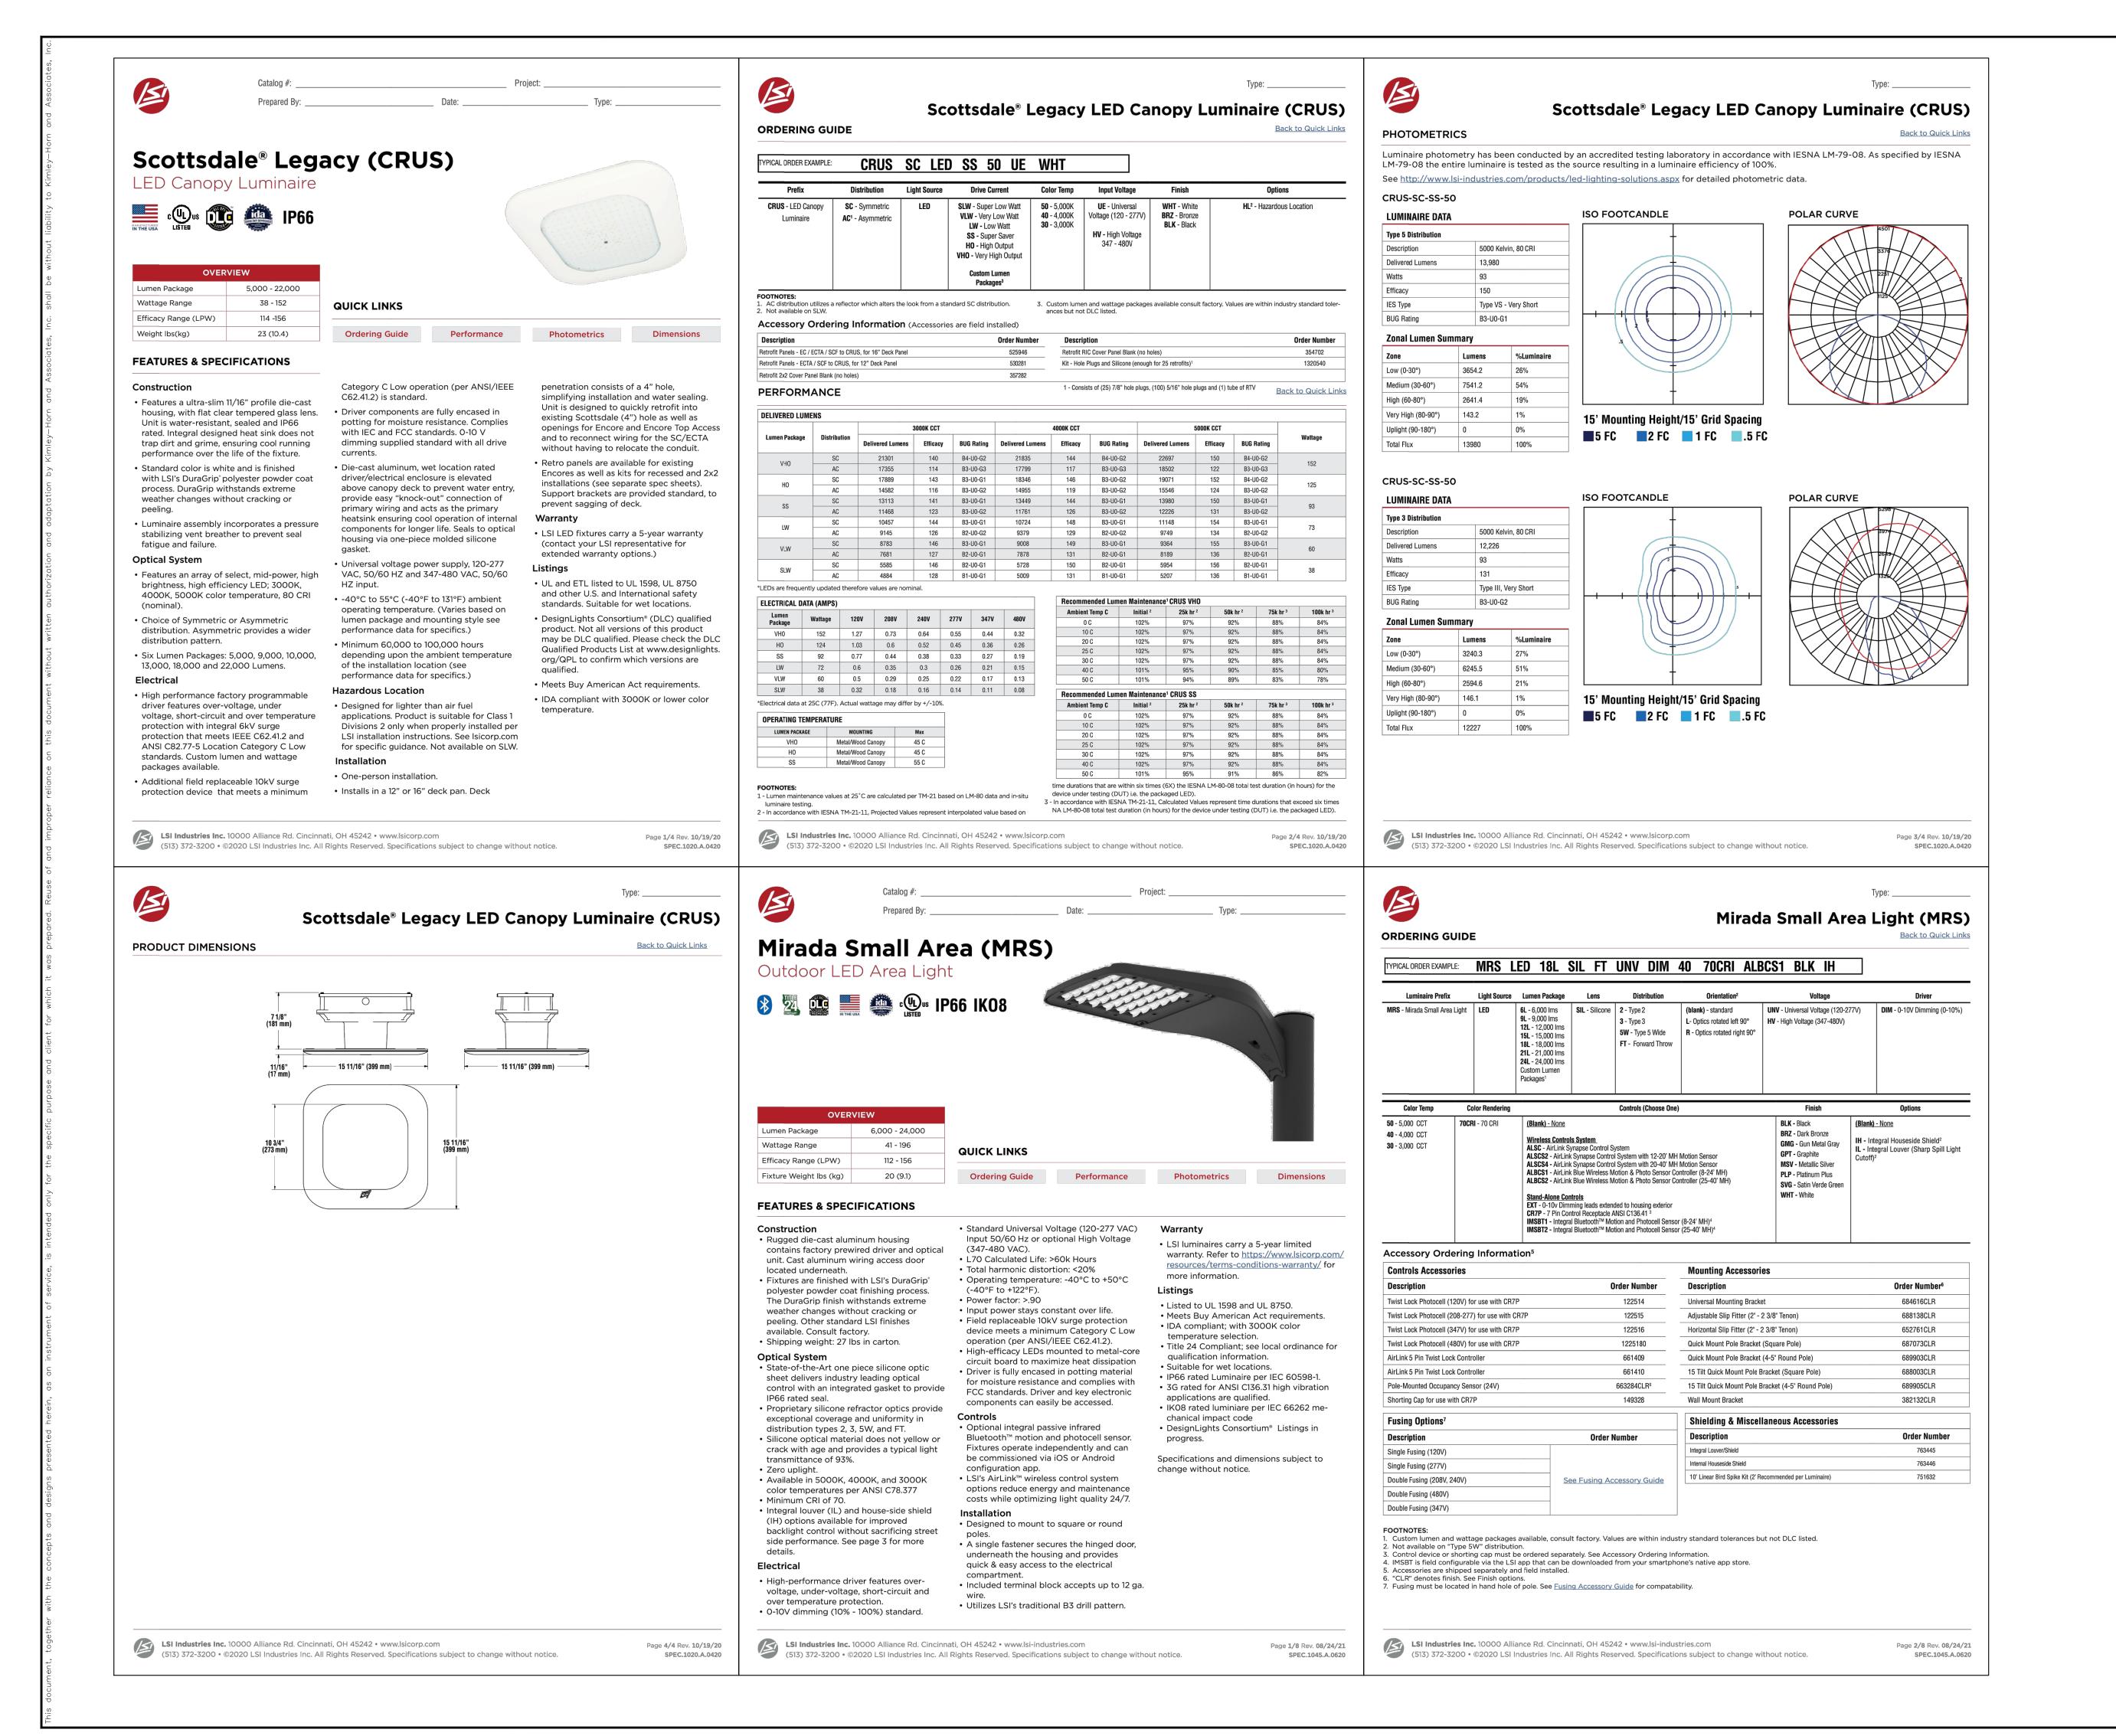

SHEET NUMBER

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Optics Rotated Left

(Optics Rotated Right)

Mirada Small Area Light (MRS)

ACCESSORIES/OPTIONS

Integral Louver (IL) and House-Side Shield (IH)

Accessory louver and shield available for improved backlight control without sacrificing street side performance. LSI's Integral Louver (L) and Integral House-Side Shield (IH) options deliver backlight control that significantly reduces spill light behind the poles for applications with pole locations close to adjacent properties. The design maximizes forward reflected light while reducing glare, maintaining the optical distribution selected, and most importantly eliminating light trespass. Both options rotate with the optical distribution.

Luminaire Shown with Integral Louver (IL)

Luminaire Shown with **IMSBT Option**



7 Pin Photoelectric Control

7-pin ANSI C136.41-2013 control receptacle option available for twist lock photocontrols or wireless control modules. Control accessories sold separately. Dimming leads from the receptacle will be connected to the driver dimming leads (Consult factory for alternate wiring).

Luminaire Shown with CR7P





Delivered Lumens*												
Lumen Distribution CRI		CDI	3000K CCT			4000K CCT			5000K CCT			Γ
Package Distribution	UNI	Delivered Lumens	Efficacy	BUG Rating	Delivered Lumens	Efficacy	BUG Rating	Delivered Lumens	Efficacy	BUG Rating		
	2		6045	148	B2-U0-G1	6268	154	B2-U0-G1	6253	153	B2-U0-G1	
- CI	3	70	6145	151	B1-U0-G2	6372	156	B1-U0-G2	6357	156	B1-U0-G2	
6L	5W		5812	142	B3-U0-G1	6,026	148	B3-U0-G1	6012	147	B3-U0-G1	
	FT		5947	146	B1-U0-G1	6166	151	B1-U0-G1	6152	151	B1-U0-G1	1
	2		9091	145	B2-U0-G2	9484	152	B2-U0-G2	9462	151	B2-U0-G2	
	9L 3 70 FT	70	9241	148	B2-U0-G2	9641	154	B2-U0-G2	9619	154	B2-U0-G2	
9L			8740	140	B3-U0-G2	9,118	146	B3-U0-G2	9097	144	B3-U0-G2	
			8943	143	B2-U0-G2	9330	149	B2-U0-G2	9308	149	B2-U0-G2	
	2		12132	141	B3-U0-G2	12685	148	B3-U0-G2	12514	146	B3-U0-G2	Г
401	3	70	12333	143	B2-U0-G2	12894	150	B2-U0-G2	12721	148	B2-U0-G2	
12L	5W	70	11664	136	B4-U0-G2	12195	142	B4-U0-G2	12031	140	B4-U0-G2	
	FT	1	11935	139	B2-U0-G2	12479	145	B2-U0-G2	12311	143	B2-U0-G2	1

	rı .		6943	143	B2-00-G2	9330	149	B2-00-G2	9308	149	B2-00-G2	
	2		12132	141	B3-U0-G2	12685	148	B3-U0-G2	12514	146	B3-U0-G2	
101	12L 3	70	12333	143	B2-U0-G2	12894	150	B2-U0-G2	12721	148	B2-U0-G2	86
IZL	5W		11664	136	B4-U0-G2	12195	142	B4-U0-G2	12031	140	B4-U0-G2	00
	FT		11935	139	B2-U0-G2	12479	145	B2-U0-G2	12311	143	B2-U0-G2	
	2		14220	128	B3-U0-G2	15167	137	B3-U0-G2	14488	131	B3-U0-G2	
15L	3	70	14938	135	B2-U0-G2	15933	144	B2-U0-G2	15219	137	B2-U0-G2	111
IDL	5W	70	14304	129	B4-U0-G2	15257	137	B4-U0-G2	14574	131	B4-U0-G2	111
	FT		14342	129	B2-U0-G2	15297	138	B2-U0-G2	14612	132	B2-U0-G2	
	2		16438	122	B3-U0-G3	17532	130	B3-U0-G3	16747	124	B3-U0-G3	
18L	3	70	17267	128	B3-U0-G3	18417	137	B3-U0-G3	17592	131	B3-U0-G3	135
IOL	5W] /0	16535	123	B4-U0-G2	17636	133	B5-U0-G3	16846	125	B4-U0-G2	133
	FT		16578	123	B3-U0-G3	17682	131	B3-U0-G3	16890	125	B3-U0-G3	
	2		19488	118	B3-U0-G3	20786	126	B3-U0-G3	19885	120	B3-U0-G3	
21L	3	70	20472	124	B3-U0-G3	21835	132	B3-U0-G3	20857	126	B3-U0-G3	165
ZIL	5W] /0	19604	119	B5-U0-G3	20,909	126	B5-U0-G3	19973	121	B5-U0-G3	
	FT		19655	119	B3-U0-G4	20964	127	B3-U0-G4	20025	121	B3-U0-G4	
	2		21976	112	B3-U0-G3	23439	120	B3-U0-G3	22390	114	B3-U0-G3	

23578

B5-U0-G3

113 B3-U0-G3

	FT		22164
*I EDs are free	augntly undated :	thoroforo	values are nemir

ELECTRICAL DATA (AMPS)*						
Lumens	120V	208V	240V	277V	347V	480V
6L	0.34	0.20	0.17	0.15	0.12	0.09
9L	0.52	0.30	0.26	0.23	0.18	0.13
12L	0.72	0.41	0.36	0.31	0.25	0.18
15L	0.93	0.53	0.46	0.40	0.32	0.23
18L	1.12	0.65	0.56	0.49	0.39	0.28
21L	1.38	0.80	0.69	0.60	0.48	0.34
24L	1.63	0.94	0.82	0.71	0.56	0.41

*Electrical data at 25°C (77°F). Actual wattage may differ by +/-10%

Ambient Temp		Lumen Multiplier				
С	0 hrs. ²	25K hrs. ²	50K hrs.2	75K hrs.3	100K hrs	
0 C - 25 C	100%	95%	89%	84%	79%	
40 C	100%	94%	87%	80%	74%	

22522

120 B5-U0-G3

115 B5-U0-G3

in-situ luminaire testing. 2. In accordance with IESNA TM-21-11, Projected Values represent interpolated value based on time durations that are within six times (6X)the IESNA LM-80-08 total test duration (in hours) for the device under testing ((DUT) i.e. the packaged LED chip).

3. In accordance with IESNA TM-21-11, Calculated Values represent time durations that exceed six times NA LM-80-08 total test duration (in hours) for the device under testing ((DUT) i.e. the packaged LED chip).



Optics Rotated Right

(Optics Rotated Left)

SPEC.1045.A.0620

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PHOTOMETRICS

Mirada Small Area Light (MRS)

Back to Quick Links

Luminaire photometry has been conducted by a NVLAP accredited testing laboratory in accordance with IESNA LM-79-08. As specified by IESNA LM-79-08 the entire luminaire is tested as the source resulting in a luminaire efficiency of 100%. See http://www.lsi-industries.com/products/led-lighting-solutions.aspx for detailed photometric data.

MRS-LED-18L-SIL-2-40-70CRI

LUMINAIRE DATA			ISO FOOTCANDLE	POLAR CURVE
Type 2 Distribution			1	10193
Description	4000 Ke	elvin, 70 CRI		
Delivered Lumens	17,532		+	
Watts	135			
Efficacy	130		(5 (1	
IES Type	Type II -	- Short	5	
BUG Rating	B3-U0-0	G3		
Zonal Lumen Sum	ımary			
Zone	Lumens	%Luminaire	Ŧ	
Low (0-30)°	2831	16%		
Medium (30-60)°	10310	59%	<u> </u>	
High (60-80)°	4208	24%	20' Mounting Height/20' Grid Spacing	
Very High (80-90)°	184	1%	■ 5 FC ■ 2 FC ■ 1 FC ■ 0.5	
Unlight (00 100\0		00/		1 0

MRS-LED-18L-SIL-3-40-70CRI

Uplight (90-180)° 0

Total Flux

LUMINAIRE DATA					
Type 3 Distribution					
Description	4000 Kelvin, 70 CRI				
Delivered Lumens	18,417				
Watts	135				
Efficacy	137				
IES Type	Type III - Short				
BUG Rating	B3-U0-G3				

17532

100%

Zonal Lumen Summary							
Zone	Lumens	%Luminaire					
Low (0-30)°	2329	13%					
Medium (30-60)°	10634	61%					
High (60-80)°	5246	30%					
Very High (80-90)°	208	1%					

20' Mounting Height/20' Grid Spacing

■5 FC ■2 FC ■1 FC ■0.5 FC 0% 18417 100%

ISO FOOTCANDLE

Uplight (90-180)°

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Mirada Small Area Light (MRS)


PHOTOMETRICS (CONT)


MRS-LED-18L-SIL-FT-40-70CRI LUMINAIRE DATA

Type FT Distribution	
Description	4000 Kelvin, 70 CRI
Delivered Lumens	17,682
Watts	135
Efficacy	131
IES Type	Type III - Short
BUG Rating	B3-U0-G2

Zonal Lumen Summary					
Zone	Lumens	%Lun			
Low (0-30)°	2255	13%			
Medium (30-60)°	9463	54%			

zonar zamon oumnur,					
Zone	Lumens	%Luminaire			
Low (0-30)°	2255	13%			
Medium (30-60)°	9463	54%			
High (60-80)°	5696	32%			
Very High (80-90)°	268	2%			
Uplight (90-180)°	0	0%			
Total Flux	17682	100%			

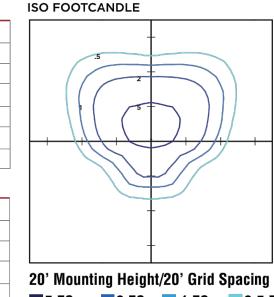

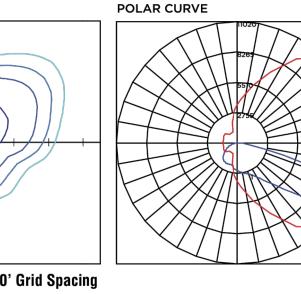

POLAR CURVE


■5 FC ■2 FC ■1 FC ■0.5 FC


ISO FOOTCANDLE


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MRM-LED-30L-SIL-5W-40-70CRI

LUMINAIRE DATA				
Type 5W Distribution				
Description	4000 Kelvin, 70 CRI			
Delivered Lumens	17,636			
Watts	135			
Efficacy	131			
IES Type	Type VS - Short			
BUG Rating	B4-U0-G2			



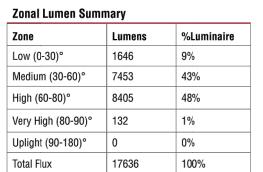


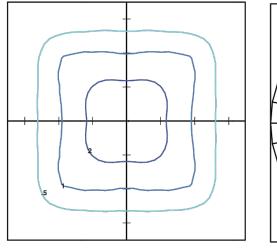

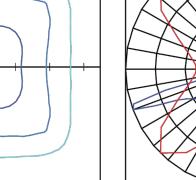20' Mounting Height/20' Grid Spacing ■5 FC ■2 FC ■ 1 FC ■ 0.5 FC


Mirada Small Area Light (MRS)

PRODUCT DIMENSIONS

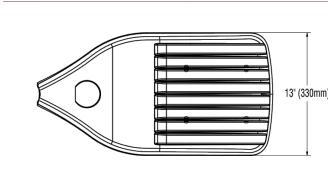

7" (180mm)	
	25" (634mm)

LUMINA	IRE EPA (CHART -	MRS						
Tilt Degree		0° 30° 45°		Tilt Degree		0°	30°	45°	
-	Single	0.5	1.3	1.8	- ! -	T90°	1.4	2.3	2.6
	D180°	0.9	1.3	1.8	*	TN120°	1.4	1.9	2.3
₹	D90°	0.9	1.8	2.2		Q90°	1.4	2.3	2.6

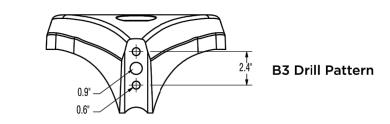

CONTROLS

AirLink Wireless Lighting Controller

The AirLink integrated controller is a California Title 24 compliant lighting controller that provides real-time light monitoring and control with utility-grade power monitoring. It includes a 24V sensor input and power supply to connect a sensor into the outdoor AirLink wireless lighting system. The wireless integrated controller is compatible with this fixture. Click here to learn more about AirLink.

Integral Bluetooth™ Motion and Photocell Sensor (IMSBT)

Slim low profile sensor provides multi-level control based on motion and/or daylight. Sensor controls 0-10 VDC LED drivers and is rated for cold and wet locations (-30° C to 70° C). Two unique PIR lenses are available and used based on fixture mounting height. All control parameters are adjustable via an iOS or Android App capable of storing and transmitting sensor profiles. Click here to learn more about IMSBT.

AirLink Blue

Wireless Bluetooth Mesh Outdoor Lighting Control System that provides energy savings, code compliance and enhanced safety/security for parking lots and parking garages. Three key components; Bluetooth wireless radio/sensor controller, Time Keeper and an iOS App. Capable of grouping multiple fixtures and sensors as well as scheduling time-based events by zone. Radio/Sensor Controller is factory integrated into Area/Site, Wall Mounted, Parking Garage and Canopy luminaires. Click here to learn more about AirLink Blue.

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Mirada Small Area Light (MRS)

POLAR CURVE

POLES & BRACKETS

BKA ASF CLR

LSI offers a full line of poles and mounting accessories to complete your lighting assembly. Aluminum and steel in both square and round shafts. In addition, LSI offers round tapered, fluted and hinge based poles. Designed and engineered for durability and protected with our oven baked DuraGrip Protection System. Also available with our DuraGrip+ Protection system for unmatched corrosion resistance and an extended warranty. American made in our Ohio facility with industry leading lead times.

Click here to learn more details about poles & brackets.



The 3G rated UMB allows for seamless integration of LSI luminaires onto existing/ retrofit or new onstruction poles. The UMB was designed for square or round (tapered or straight) poles with two mounting hole spacings between 3.5" - 5".

The adjustable Slip Fitter is a 3G rated rugged


luminaires onto a onto a 2" iron pipe , 2 3/8 OD

tenon. The Adjustable Slip Fitter can be rotated

180° allowing for tilting LSI luminaires up to 45°

die cast aluminum adapter to mount LSI


and 90° when using a vertical tenon.

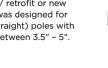

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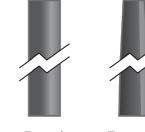
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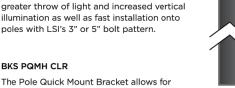
Pole


14'-39'

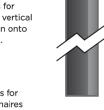

The Pole Quick Mount Bracket allows or preset 15° uptilt of LSI luminaires for


LSI's B3 or B5 standard pole bolt patterns.



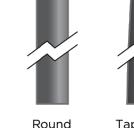

Pole

10'-30'

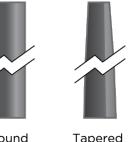

Pole

20'-39'

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SPEC.1074.A.0920

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SPEC.1074.A.0920



July 31, 2022

Mr. Kevin Lewis AICP, CZO Town of Knightdale 950 Steeple Square Court Knightdale, NC 27545

RE: EP Mart #10, Relief from UDO Requirements

Dear Mr. Lewis,

EP Mart intends to re-develop the subject site with a newer store with fuel dispensers and EV chargers. In recognition of their intent to provide a high-quality product, the following deviations are proposed from Unified Development ordinance standards along with the rationale for those deviations

- Section 6.8 Mixed Use Building is required to be mult-story. The subject property consists of a corner lot designated as part of a "Priority Investment, Growth Activity Center" in the 2035 Comprehensive Plan. The redevelopment of this existing fuel station will provide the appearance of a two-story building (27 feet maximum height with multiple levels of windows) tending to shield the view of the accessory pump islands from traffic approaching from the west or south. The site plan pulls the building to the corner Streets paralleling the rights of way. The rejuvenated site will provide a higher quality aesthetic on the property including enhanced landscaping, and an outdoor seating amenity. The redevelopment strengthens the mix of uses on this quadrant as it is a complement to the existing hotel and other service uses.
- Section 6.8 Maximum 10- foot building setback. The rejuvenated site orients and pulls the building to both Knightdale Boulevard and First Avenue providing convenient pedestrian connections and space for a pickup queue of food items from the store.
- In lieu of sidewalk along the Money Court frontage, it is understood that sidewalk connection south of the property along First Avenue is highly desirable to Knightdale Station Park. As such, a connection is proposed on First Avenue.
- UDO 5.5.B.4. The fuel canopy columns will be covered with masonry; however, the
 fuel provider has restrictions related to the branding of the fuel provided. This is
 similar to other fuel providers in Town.